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ABBREVIATIONS

ACT	ACOUSTICAL CEILING TILE	N/A	NOT APPLICABLE
AFF	ABOVE FINISH FLOOR	O.C.	ON CENTER
AHU	AIR HANDLING UNIT	OCC	OCCUPANT
AL	ALUMINUM	PF	PREFINISHED
CI	CONTINUOUS INSULATION	REF	REFERENCE
CJ	CONTROL JOINT	REQ	REQUIRED
DRY	DRYER	SF	SQUARE FOOT / FEET
ELEC	ELECTRICAL	SIM	SIMILAR
EQ.	EQUAL	SS	STAINLESS STEEL
ETR	EXISTING TO REMAIN	STD	STAINED
EXIST	EXISTING	STL	STEEL
FT	FOOT / FEET	TLT	TOILET
F.V.	FIELD VERIFY	UNO	UNLESS NOTED OTHERWISE
GB	GRAB BAR	WASH	WASHER
GYP	GYPSUM	WC	WHEELCHAIR
HGT	HEIGHT	WD	WOOD
HR	HOUR		
MAX	MAXIMUM		
MECH	MECHANICAL		
MTL	METAL		
MIN	MINIMUM		

DOOR SCHEDULE			
Door Number	Door		Comments
	Width	Height	

DOOR SCHEDULE			
Door Number	Door		Comments
	Width	Height	
Exterior			
100A	3' - 0 5/16"	7' - 11 1/2"	
100B	18' - 1"	7' - 11"	Garage Door
100C	15' - 9"	7' - 11 1/2"	
100D	3' - 0"	9' - 6"	
Interior			
101A	4' - 0"	8' - 0"	Cased opening
104A	16' - 0"	9' - 0"	
106A	3' - 0"	8' - 0"	
107A	2' - 4"	8' - 0"	
108A	2' - 6"	8' - 0"	
200A	3' - 0"	8' - 0"	Cased opening
200B	2' - 8"	8' - 0"	
201A	2' - 4"	8' - 0"	
202A	2' - 4"	8' - 0"	
203A	2' - 8"	8' - 0"	
204A	2' - 4"	8' - 0"	
205A	2' - 4"	8' - 0"	
206A	2' - 8"	8' - 0"	
207A	2' - 6"	8' - 0"	
208A	2' - 4"	8' - 0"	
209A	2' - 6"	8' - 0"	
210A	3' - 0"	8' - 0"	Pocket Door
210B	3' - 0"	8' - 0"	Pocket Door
211A	2' - 4"	8' - 0"	
212A	3' - 0"	8' - 0"	
212B	2' - 4"	8' - 0"	
212C	5' - 9"	8' - 0"	Cased opening
212D	2' - 4"	8' - 0"	Glass Shower Door
213A	3' - 0"	8' - 0"	Cased opening
213B	2' - 8"	8' - 0"	
Motorized Retractable Screen			
S1	20' - 6"	9' - 6"	Motorized Retractable Screen

WINDOW SCHEDULE			
Mark	Width	Height	Head Height

WINDOW SCHEDULE			
Mark	Width	Height	Head Height
102	2' - 8"	6' - 0"	8' - 0"
103	2' - 8"	6' - 0"	8' - 0"
104	5' - 0"	6' - 0"	8' - 0"
105	2' - 8"	6' - 0"	8' - 0"
106	2' - 8"	6' - 0"	8' - 0"
107	2' - 8"	6' - 0"	8' - 0"
201	2' - 4"	4' - 0"	8' - 0"
202	2' - 8"	6' - 0"	9' - 0"
203	2' - 8"	6' - 0"	9' - 0"
204	2' - 8"	6' - 0"	9' - 0"
205	2' - 8"	6' - 0"	8' - 0"
206	2' - 8"	6' - 0"	8' - 0"
207	2' - 8"	6' - 0"	8' - 0"
208	2' - 8"	6' - 0"	8' - 0"
209	2' - 8"	6' - 0"	8' - 0"
210	2' - 8"	6' - 0"	8' - 0"
211	2' - 8"	6' - 0"	8' - 0"
212	2' - 8"	6' - 0"	8' - 0"
213	2' - 8"	6' - 0"	8' - 0"
214	2' - 8"	6' - 0"	8' - 0"
215	2' - 8"	6' - 0"	8' - 0"
216	2' - 8"	6' - 0"	8' - 0"
217	2' - 8"	6' - 0"	8' - 0"



GENERAL PROJECT NOTES:

- CONTRACTOR SHALL VISIT PROPERTY AND REVIEW EXISTING CONDITIONS PRIOR TO START OF WORK. ANY DISCREPANCIES OR CONFLICTS SHALL BE BROUGHT TO THE ATTENTION OF THE ARCHITECT PRIOR TO SUBMITTING BID.
- WORK SHALL MEET THE REQUIREMENTS SET FORTH BY THE LATEST EDITION OF CODES STATED IN THE CODE ANALYSIS AS WELL AS THE STATE AND LOCAL AUTHORITIES HAVING JURISDICTION.
- ALL MATERIALS AND EQUIPMENT REFERRED TO IN LEGENDS, GENERAL NOTES, OR KEYNOTES SHALL BE NEW AND INSTALLED UNDER THE SCOPE OF THIS PROJECT UNLESS NOTED OTHERWISE TO BE FURNISHED AND INSTALLED BY OWNER.
- CONTRACTOR SHALL EMPLOY SKILLED LABOR TO PERFORM THE SCOPE OF WORK IN ACCORDANCE WITH BEST PRACTICES OF THE TRADE FOR ALL CATEGORIES.
- CONTRACTOR SHALL COORDINATE THEIR WORK IN ACCORDANCE WITH OTHER TRADES AND SUBCONTRACTORS TO FACILITATE A SMOOTH WORK PROGRESSION.
- CONTRACTOR SHALL SECURE OWNER'S APPROVAL OF ANY SUBSTITUTION PRODUCTS PRIOR TO INSTALLATION OF WORK. OWNER SHALL SUPPLY TO CONTRACTOR ANY SUBSTITUTIONS IN PROMPT MANNER TO CONTINUE SMOOTH WORK PROGRESSION.
- CONTRACTOR SHALL BE RESPONSIBLE FOR OBTAINING AND PAYING ALL REQUIRED PERMITS AND APPROVALS FROM STATE AND AUTHORITIES HAVING JURISDICTION. CONTRACTOR SHALL NOTIFY AND SCHEDULE ALL REQUIRED INSPECTIONS AND APPROVALS WITH THE VARIOUS AUTHORITIES HAVING JURISDICTION.
- CONTRACTOR SHALL PROVIDE AND MAINTAIN SUITABLE PROTECTION FOR ALL EMPLOYEES, THE PUBLIC, AND VARIOUS OCCUPANTS DURING THE COURSE OF WORK. CONTRACTOR SHALL COMPLY WITH ALL APPLICABLE JOB SAFETY REGULATIONS.
- CONTRACTOR SHALL REMOVE ALL DEBRIS, TRASH, AND OTHER MATERIALS RESULTING FROM THE SCOPE OF WORK TO PROVIDE A CLEAN ATMOSPHERE FOR THE OWNER. ALL SUCH MATERIAL MUST BE DISPOSED OF IN A LEGAL MANNER AND THE CONTRACTOR SHALL BE RESPONSIBLE FOR ALL COSTS ASSOCIATED WITH SAID REMOVALS AND DISPOSALS.

- CONTRACTOR SHALL MAINTAIN THE PROJECT SITE IN A NEAT AND ORDERLY MANNER.
- CONTRACTOR SHALL SUBMIT ALL SAMPLES AND COLOR SELECTIONS TO THE ARCHITECT FOR REVIEW AND APPROVAL PRIOR TO INSTALLATION.
- CONTRACTOR SHALL VERIFY ALL DIMENSIONS PRIOR TO COMMENCING WORK AND SHALL BRING ANY DISCREPANCIES OR CONFLICTS TO THE ATTENTION OF THE ARCHITECT.
- CONTRACTOR SHALL COORDINATE ANY REQUIRED UTILITY INTERRUPTIONS WITH THE OWNER PRIOR TO SHUT DOWN.
- THESE DOCUMENTS HAVE BEEN PROVIDED EXCLUSIVELY FOR BASIC CONSTRUCTION PURPOSES. THE ARCHITECT DOES NOT WARRANT ANY MATERIAL, WORKMANSHIP, EQUIPMENT, HARDWARE, ETC WHETHER IMPLIED OR EXPLICITLY STATED.


PROJECT CONTACTS:

CLIENT

OWNER
MCH Construction of TN, LLC
5313 Indiana Ave
Nashville, TN 37209
Phone: 615.979.0254
Contact: Matthew Haynes

DESIGNERS

ARCHITECT
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TN License No: 106244

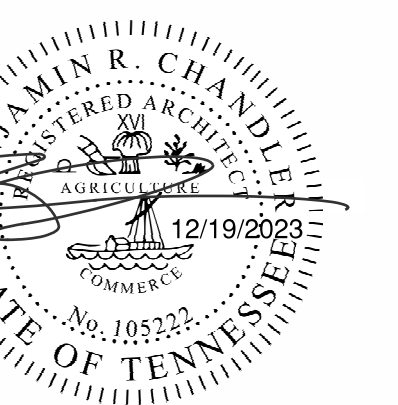

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Contractor must verify all dimensions prior to construction.

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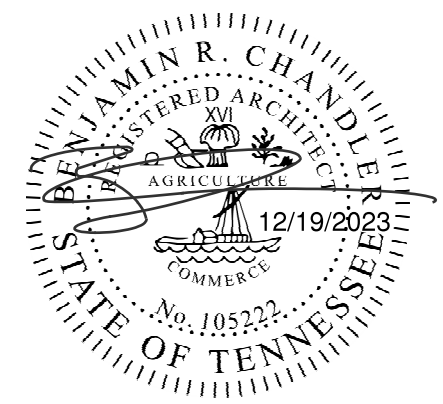
515A Continental Drive
Nashville, TN 37209



SITE PLAN LEGEND	
	ASPHALT PAVING
	UNIT B
	DECIDUOUS TREE
	EVERGREEN TREE
	SHRUB

GENERAL NOTES

- A. CONTRACTOR SHALL COORDINATE AND MAINTAIN ALL BUILDING SETBACKS AS REQUIRED BY THE LOCAL ZONING. CONTRACTOR IS RESPONSIBLE FOR LAYOUT OF BUILDING WITHIN THE SETBACK LIMITS.
- B. CONTRACTOR SHALL GRADE THE SITE AS NEEDED TO PROVIDE ADEQUATE DRAINAGE OF WATER AWAY FROM THE BUILDING.
- C. CONTRACTOR SHALL COORDINATE ALL UNDERGROUND SITE DRAINAGE PIPING WITH SITE GRADE TO ENSURE POSITIVE SLOPE TO OUTLETS.
- D. CONTRACTOR TO REVIEW DRAWINGS AND NOTIFY OWNER AND ARCHITECT IF ANY CONFLICTS ARISE.
- E. THE CONTRACTOR SHALL CLEAR THE SITE OF ONLY TREES IN THE CONSTRUCTION AREA.
- F. THE CONTRACTOR SHALL MAINTAIN EROSION CONTROL STANDARDS TO PROTECT AGAINST RUNOFF AS REQUIRED BY LOCAL AHJ.
- G. ALL CONDITIONS TO REMAIN AS IS ON SITE SHALL BE THE RESPONSIBILITY OF THE CONTRACTOR.
- H. CONTRACTOR SHALL ENSURE ALL WORK ON SITE IS IN ACCORDANCE WITH AHJ AND/OR SUBDIVISION REQUIREMENTS.
- I. DOWNSPOUTS SHALL HAVE AT MINIMUM A SPLASH BLOCK SLOPED AWAY FROM THE STRUCTURE, OR BE CONNECTED TO UNDERGROUND COLLECTION SYSTEM.
- J. IF IRRIGATION SYSTEM IS PROVIDED, IRRIGATION SYSTEM SHALL USE A SECOND METER THAT ONLY SERVICES IRRIGATION NEEDS.
- K. THE CONTRACTOR IS RESPONSIBLE FOR THE CONSTRUCTION OF ALL REQUIRED SITEWORK.
- L. THE CONTRACTOR SHALL CONNECT WITH ALL UTILITIES AND PAY FOR ALL CONNECTION AND TAPPING FEES.



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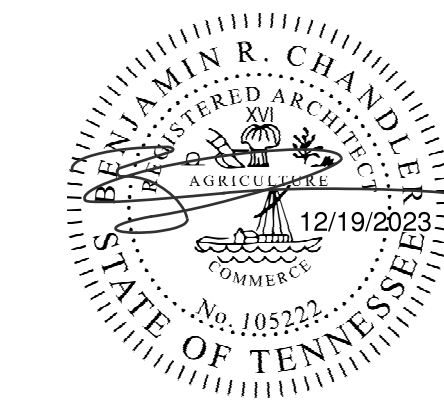
New Residence for:
MCH Construction of TN

515A Continental Drive
Nashville, TN 37209

PROJECT No. 23205A
DATE: 2023.12.19
REV DATE:

SHEET NAME
SITE PLAN AND NOTES

SHEET NUMBER
A0.50



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515A Continental Drive
Nashville, TN 37209

PROJECT No. 23205A
DATE: 2023.12.19
REV DATE:

SHEET NAME
DIMENSIONED
PLANS


SHEET NUMBER
A1.20

FLOOR PLAN LEGEND	
[---]	INDICATES SCOPE OF WORK
###	DOOR NUMBER
#	WINDOW NUMBER
#	CASEWORK ELEVATION NUMBER
#	BUILDING SECTION
#	BUILDING ELEVATION


GENERAL NOTES

- DOORS TO BE LOCATED 4" FROM ADJACENT WALL UNLESS NOTED OTHERWISE.
- CONTRACTOR SHALL COORDINATE ANY UTILITY INTERRUPTIONS WITH THE OWNER PRIOR TO CONDUCTING WORK.
- CONTRACTOR SHALL MAINTAIN REQUIRED WALL RATINGS AT PENETRATIONS, INTERSECTIONS, AND CONNECTIONS. DIMENSIONS PROVIDED ARE TO FACE OF FINISH WALL UNLESS NOTED OTHERWISE.
- CONTRACTOR SHALL ENSURE WORK COMPLIES WITH ALL APPLICABLE ACCESSIBILITY CODES.
- PROVIDED MATERIALS SHALL BE INSTALLED PER CODE REQUIREMENTS AND MANUFACTURER'S WRITTEN RECOMMENDATIONS.
- WHEN GRAPHICALLY INDICATED IN SIMILAR AREAS, VERTICALLY ALIGN WALL MOUNTED ITEMS INCLUDING OUTLETS, THERMOSTATS, FIRE PROTECTION DEVICES, ETC.
- CONTRACTOR SHALL PROVIDE, COORDINATE, AND INSTALL GYP BOARD CONTROL JOINTS. WALL JOINTS ARE TO BE PLACED AT 30'-0" MAXIMUM SPACING AND CEILING JOINTS ARE TO BE PLACED AT 50'-0" MAXIMUM SPACING.

Area Schedule (Gross Building)		
Level	Area	Comments
01 - FIRST LEVEL	1215 SF	Conditioned
01 - FIRST LEVEL	61 SF	Unconditioned (Porch)
01 - FIRST LEVEL	243 SF	Unconditioned (Porch)
01 - FIRST LEVEL	500 SF	Semi-Conditioned
02 - SECOND LEVEL	1933 SF	Conditioned
	3953 SF	

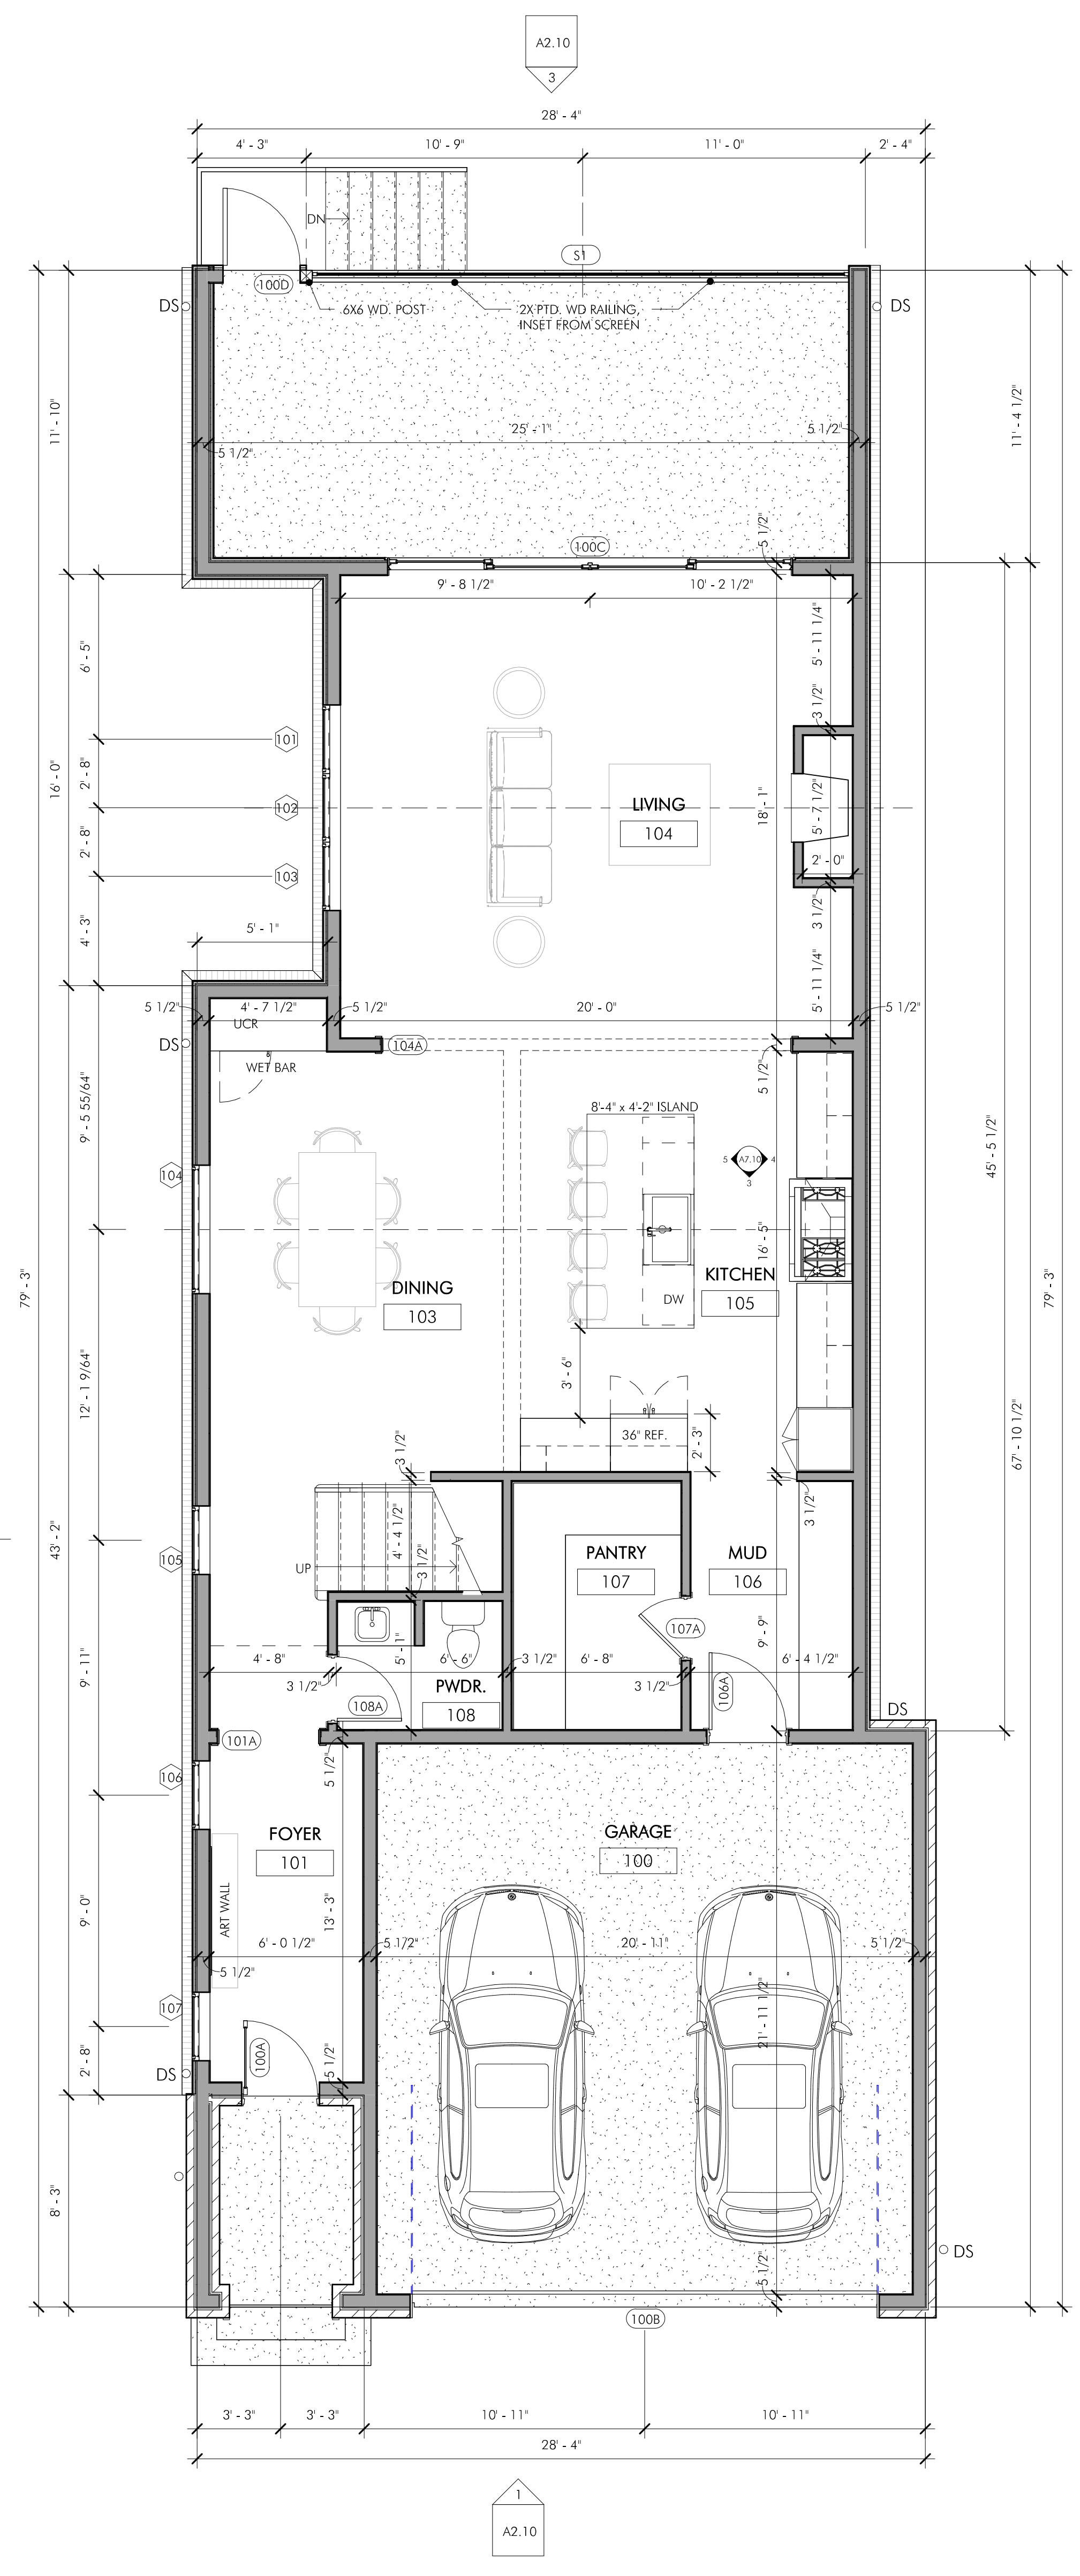


DIMENSIONED PLAN - FIRST LEVEL

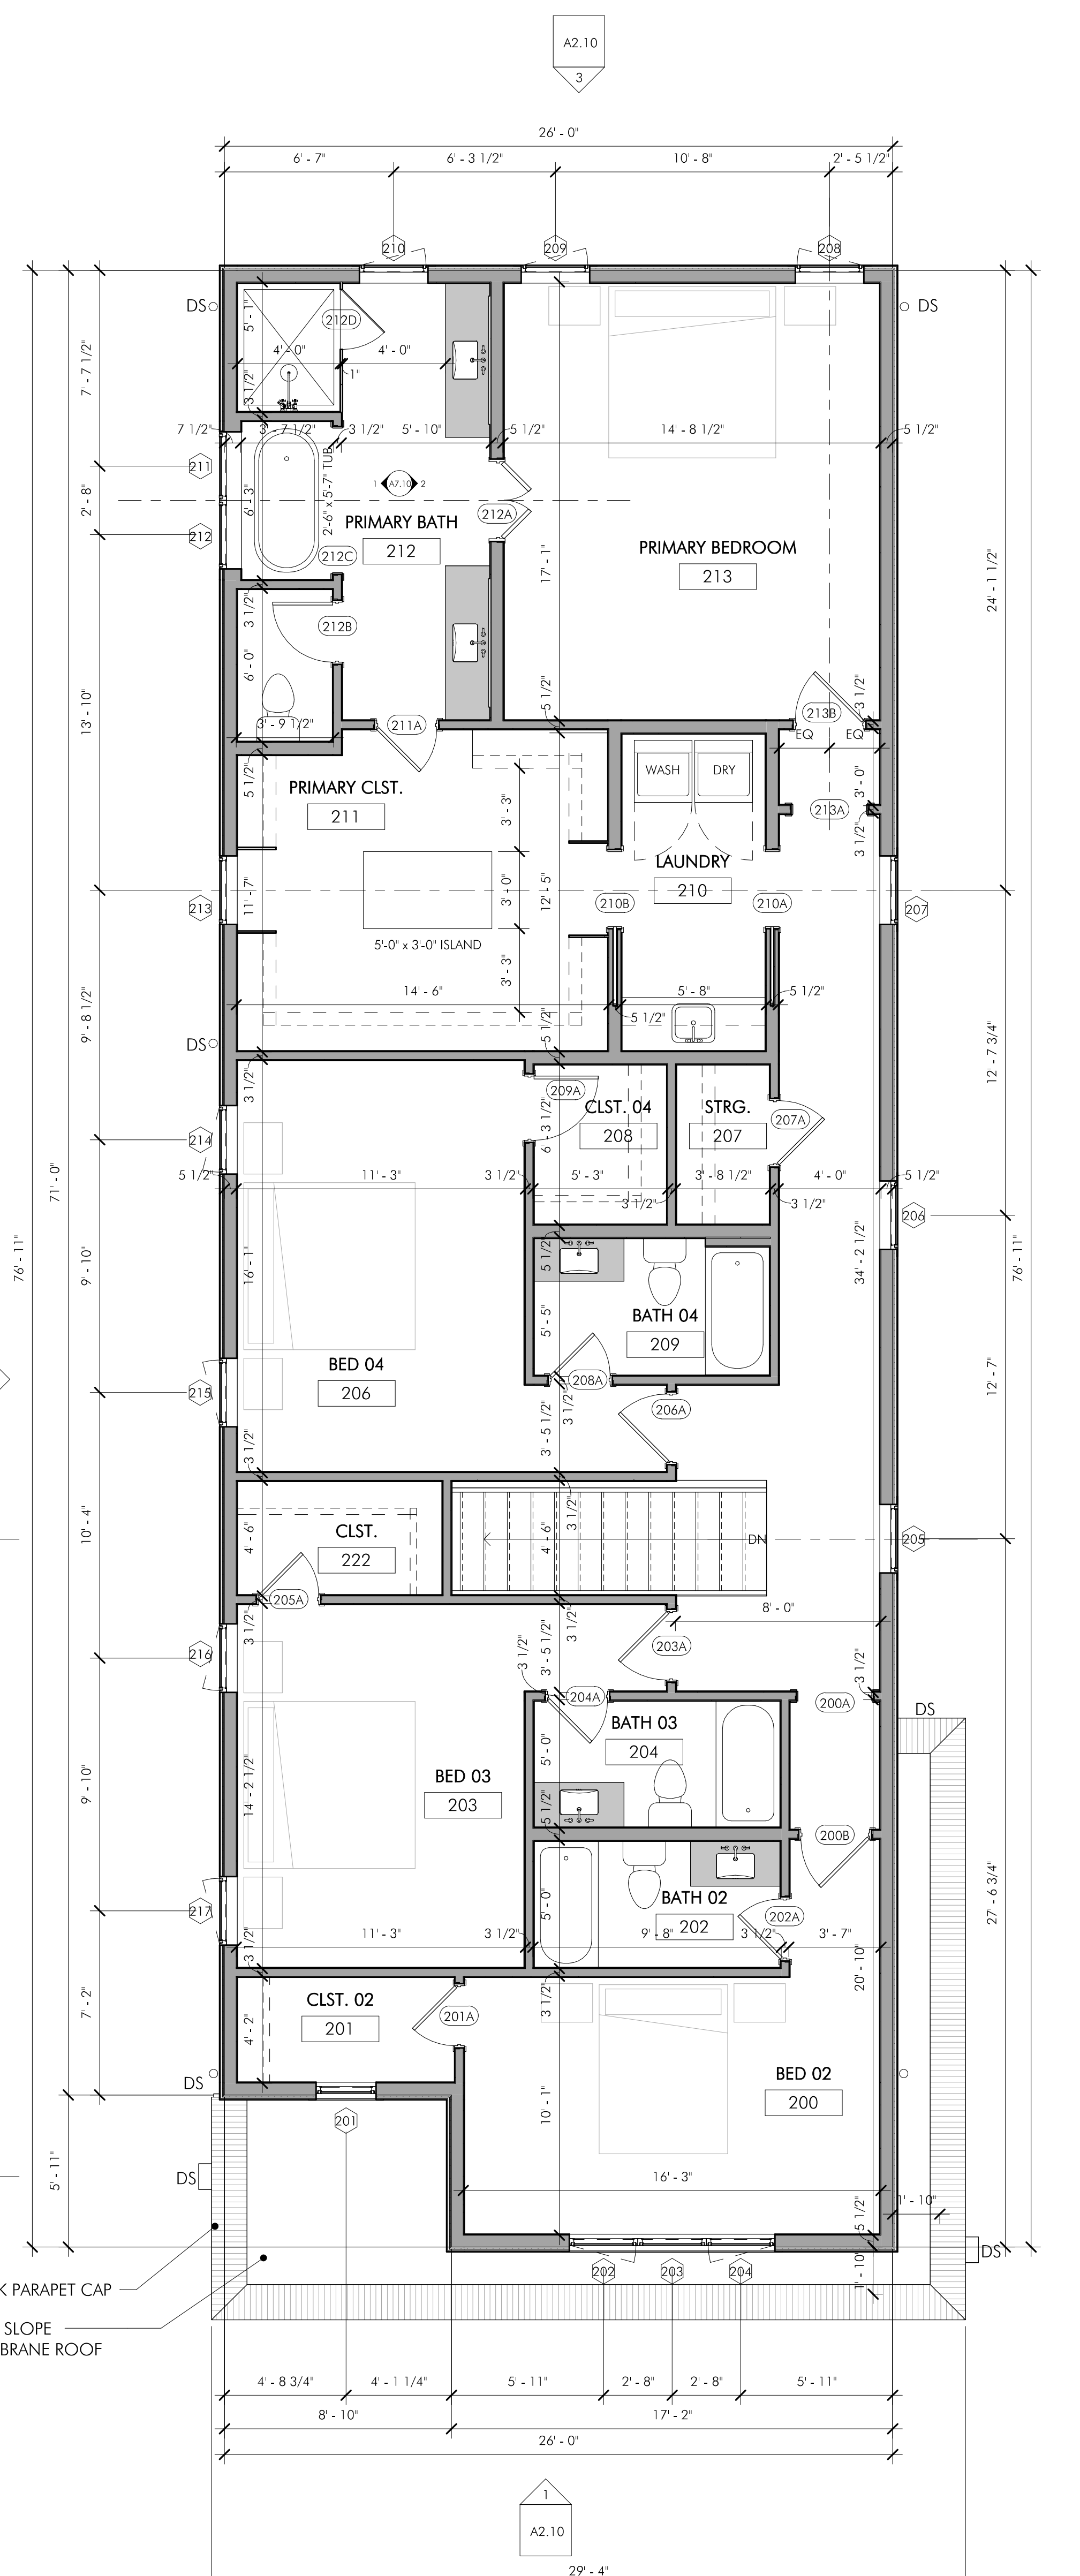


DIMENSIONED PLAN - SECOND LEVEL



BRICK PARAPET CAP
LOW SLOPE
MEMBRANE ROOF

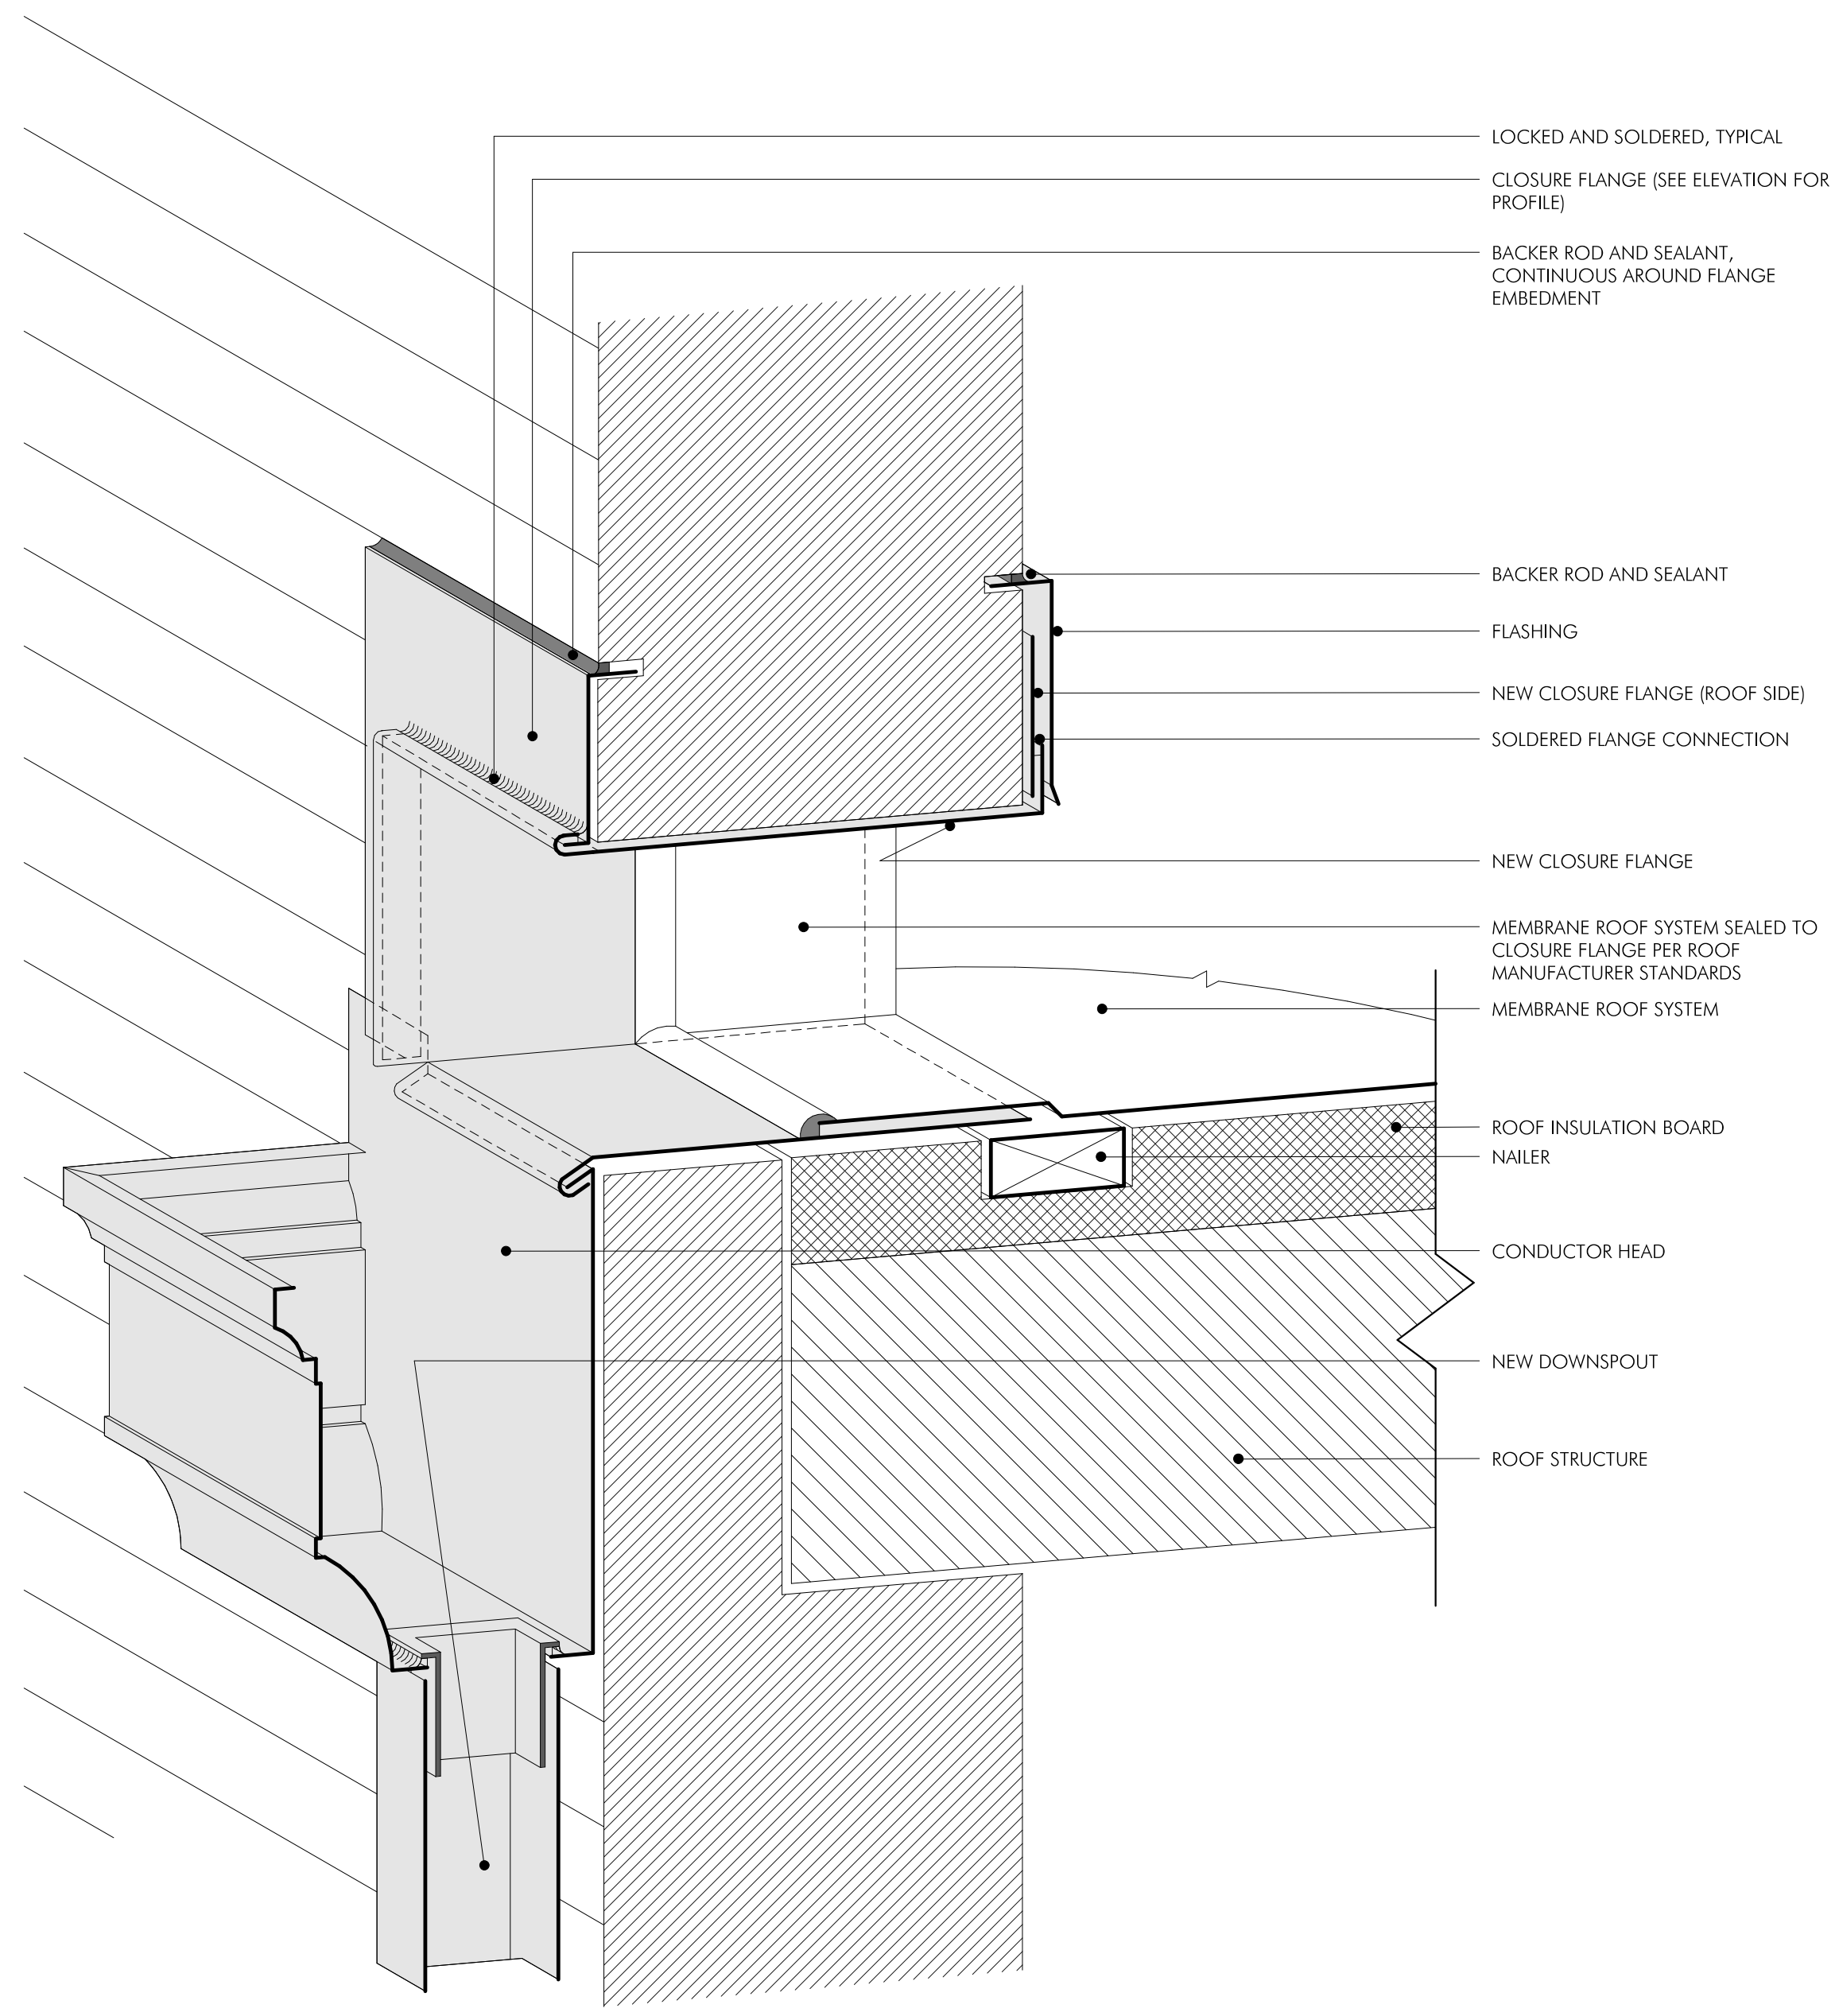

3 SCUPPER DETAIL AT NEW ROOF
3" = 1'-0"

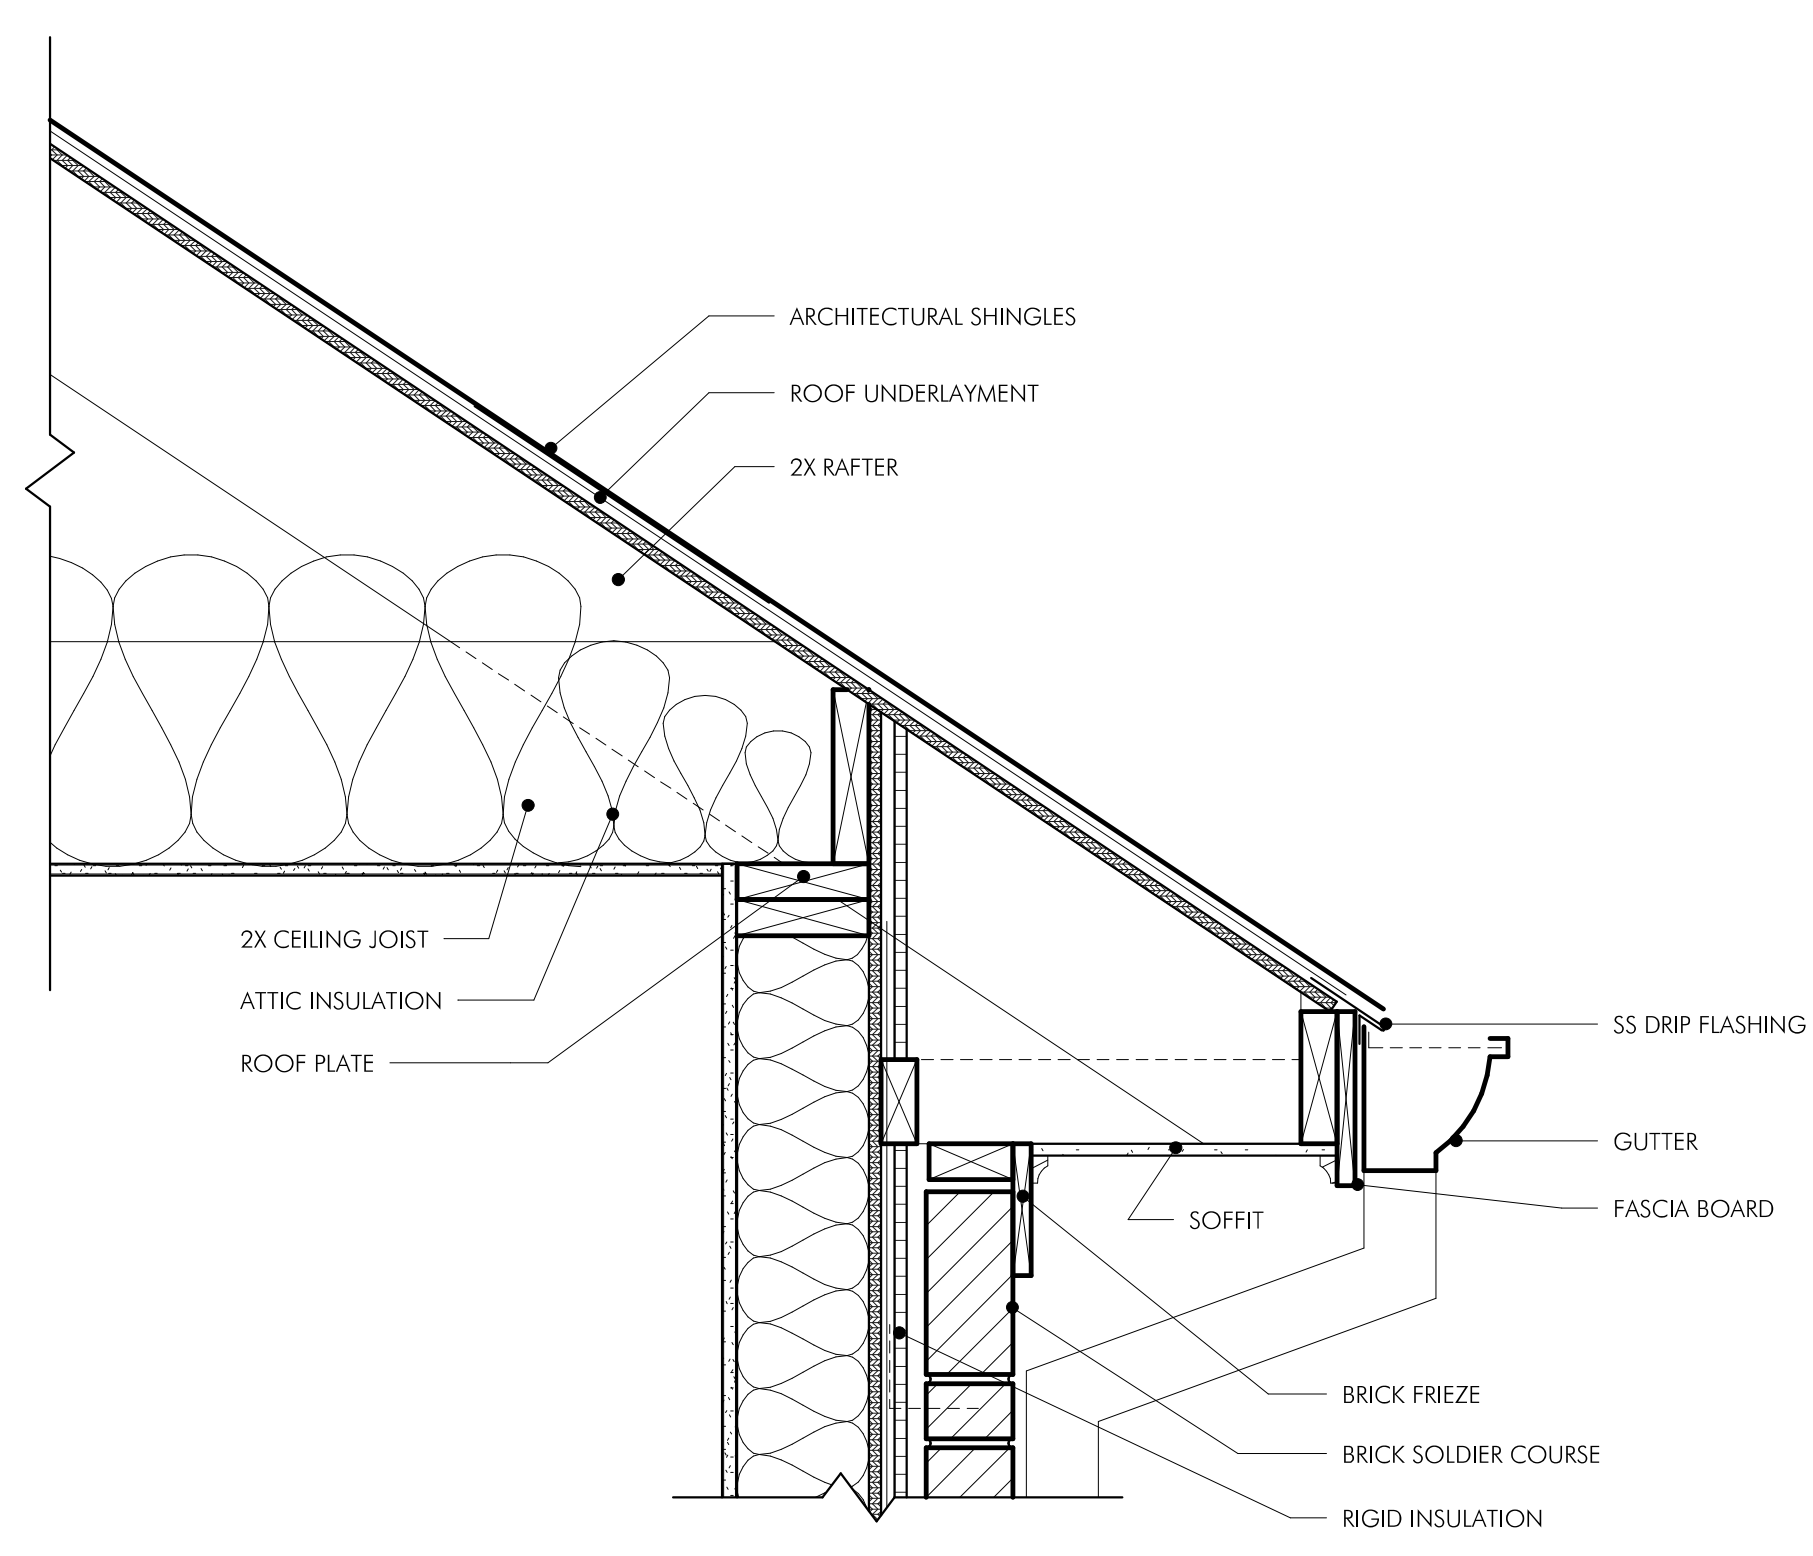


2 SOFFIT - SHINGLED ROOF
1 1/2" = 1'-0"

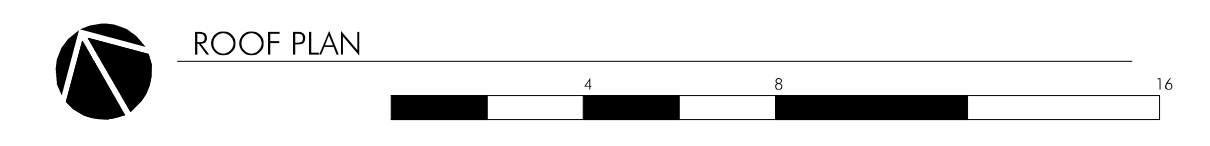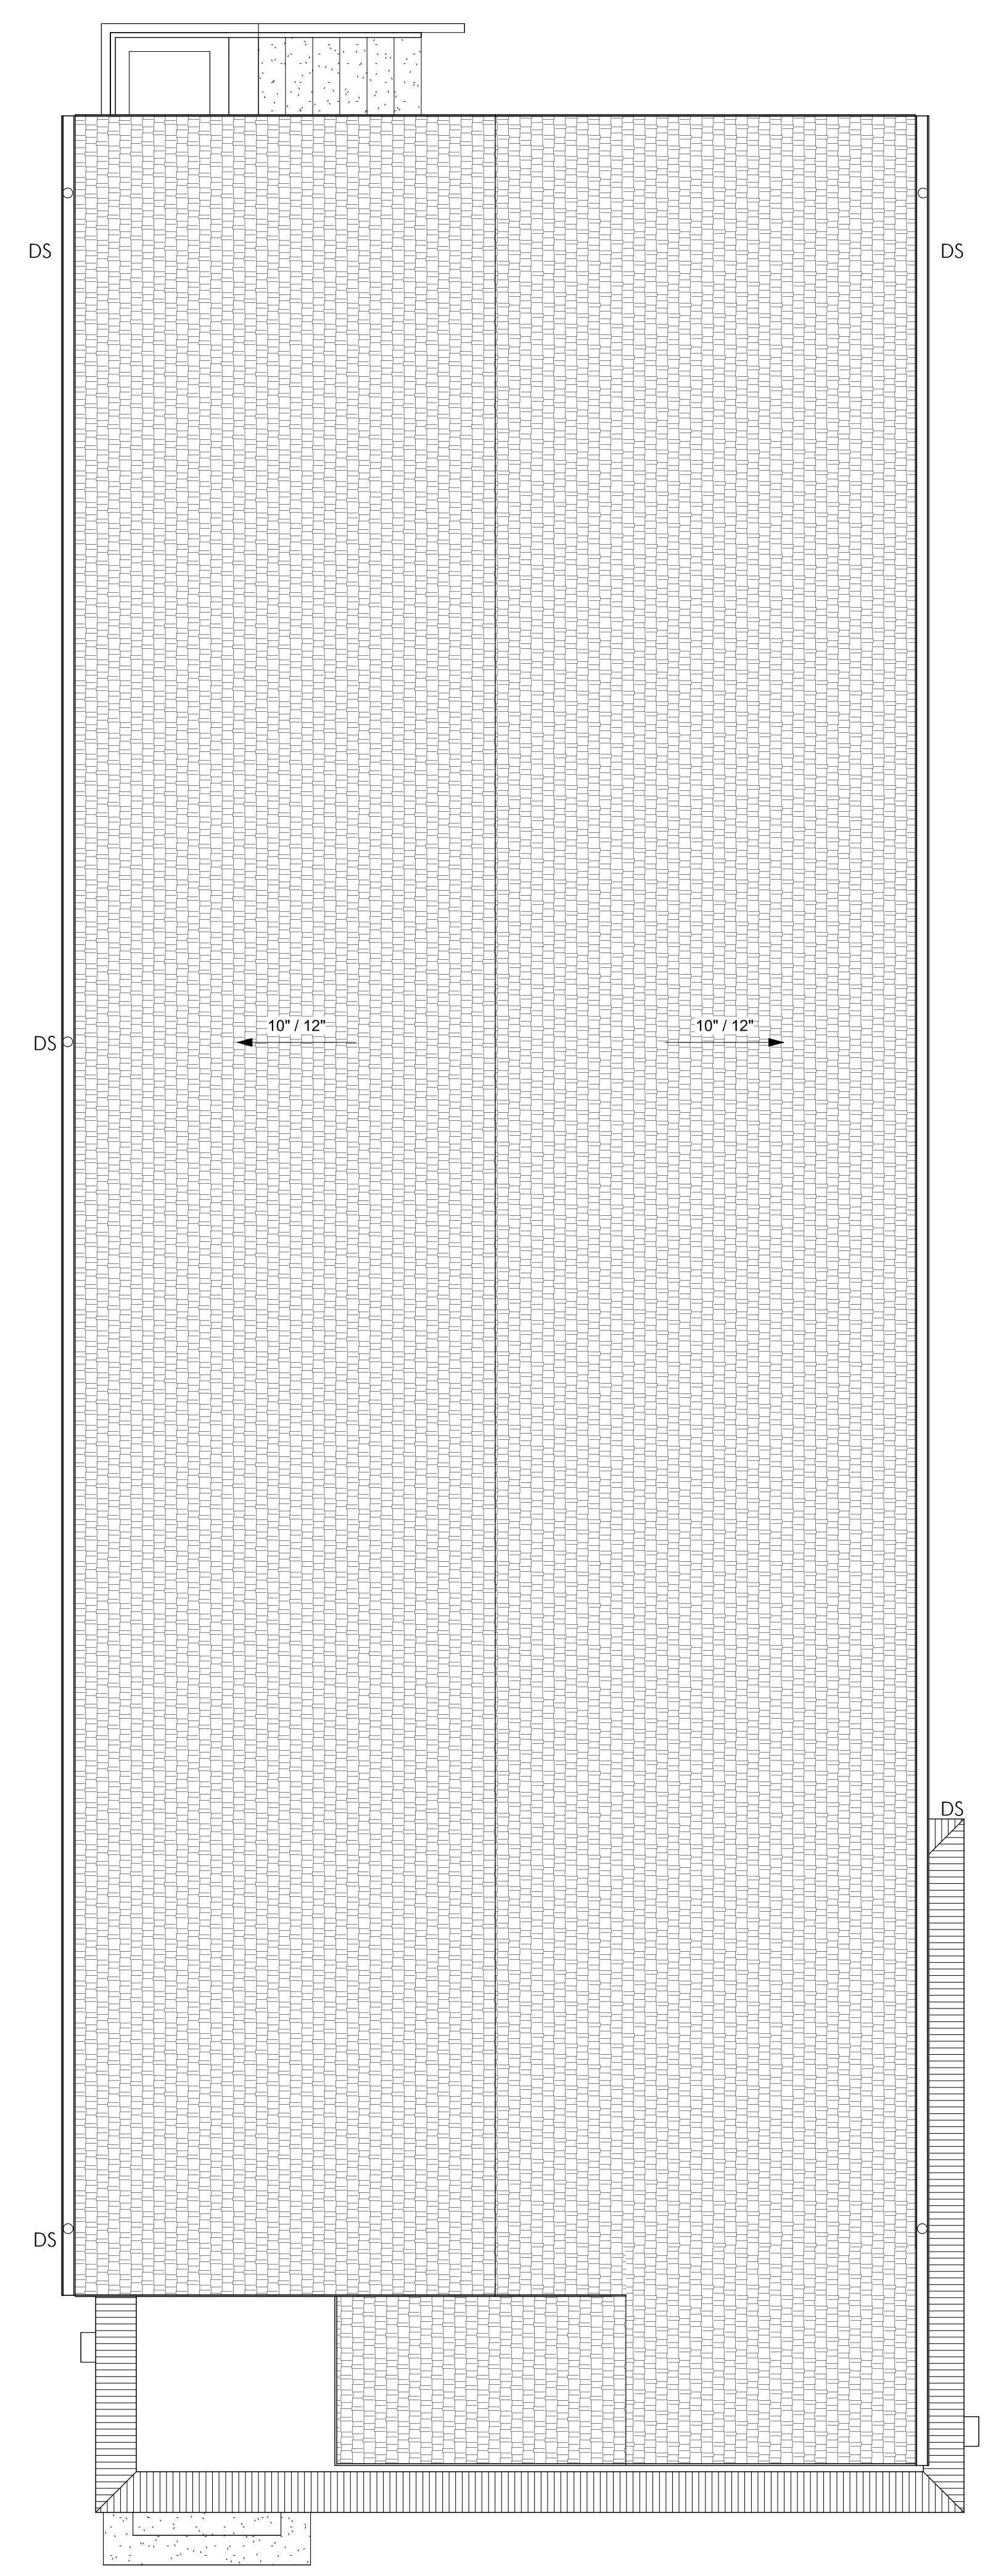

ROOF PLAN LEGEND	
	RIDGE VENT
	STANDING SEAM METAL ROOF
	SHINGLED ROOF
	DIRECTION OF ROOF SLOPE
	DOWNSPOUT

daniels chandler &

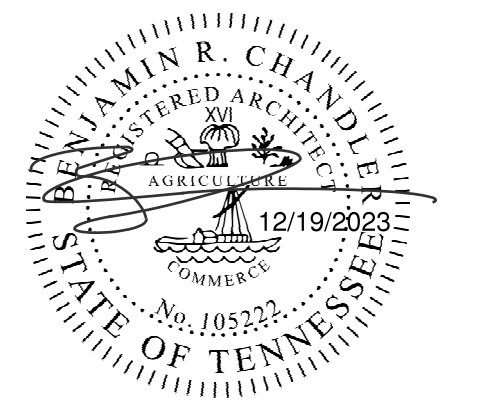

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PROJECT No. 23205A
DATE: 2023.12.19
REV DATE:

SHEET NAME
ROOF PLAN

SHEET NUMBER
A1.30

FOUNDATION LEGEND

	8' CMU FOUNDATION WALL
	4' CMU BRICK LEDGE
	CONCRETE SLAB

FOUNDATIONS NOTES

- NO FOOTINGS SHALL BE POURED ON LOOSE OR UNSUITABLE SOILS, IN WATER OR ON FROZEN GROUND.
- ALL EXTERIOR FOOTINGS TO CONFORM TO APPLICABLE CODE REQUIREMENTS FOR FROST PROTECTION.
- ALLOWABLE PRESUMPTIVE BEARING CAPACITY USED IN DESIGN OF THE FOUNDATIONS: 3000 PSF.
- ALL CONCRETE SHALL HAVE A MINIMUM COMPRESSIVE STRENGTH OF AT LEAST 3000 PSI AT 28 DAYS.
- CONTRACTOR SHALL PROVIDE TEMPORARY SUPPORTS AS REQUIRED TO PREVENT HORIZONTAL MOVEMENT OR VERTICAL SETTLEMENT WHICH WILL ENDANGER ADJACENT STRUCTURES, STREETS OR UTILITIES.
- BACKFILL SHALL NOT BE PLACED AGAINST FOUNDATION WALL UNTIL FLOOR SYSTEM IS IN PLACE OR THE FOUNDATION WALLS ARE ADEQUATELY BRACED AT THE TOP OF THE WALL.
- FOUNDATION ANCHORAGE SHALL CONSIST OF A MINIMUM OF 5/8" DIAMETER ANCHOR BOLTS AT 6'-0" O.C., 9" MINIMUM EMBEDMENT IN CONCRETE. PROVIDE SUFFICIENT BOLT LENGTH FOR BOLTING TO SILL WITH WASHER AND NUT.

SPECIAL INSPECTIONS

THIS SPECIAL INSPECTION PLAN IDENTIFIES THE RESPONSIBILITIES OF THE CONTRACTOR AND THE SPECIAL INSPECTOR IN PERFORMING THE STRUCTURAL TESTING AND INSPECTION WORK REQUIRED BY CHAPTER 17 OF THE INTERNATIONAL BUILDING CODE.

GENERAL CONTRACTOR RESPONSIBILITIES:
A WRITTEN STATEMENT OF RESPONSIBILITIES SHALL BE SUBMITTED BY THE CONTRACTOR TO THE BUILDING OFFICIAL AND THE ARCHITECT CONTAINING THE FOLLOWING:

- ACKNOWLEDGE THE SPECIAL REQUIREMENTS WITHIN THESE STRUCTURAL SPECIAL INSPECTIONS.
- ACKNOWLEDGE THAT CONTROL SHALL BE EXERCISED TO OBTAIN CONFORMANCE WITH THE CONSTRUCTION DOCUMENTS APPROVED BY THE BUILDING OFFICIAL.
- PROCEDURES FOR EXERCISING CONTROL WITH THE CONTRACTOR'S COMPANY, THE METHOD AND FREQUENCY OF REPORTING, AND THE DISTRIBUTION OF REPORTS.
- IDENTIFICATION AND QUALIFICATIONS OF THE PERSON(S) EXERCISING SUCH CONTROL AND THEIR POSITION(S) IN THE COMPANY.

THE GENERAL CONTRACTOR IS RESPONSIBLE TO ENSURE THE SPECIAL INSPECTOR IS PRESENT FOR ALL WORK REQUIRING SPECIAL INSPECTION. ANY WORK THAT REQUIRES SPECIAL INSPECTION AND IS PERFORMED WITHOUT THE SPECIAL INSPECTOR IS SUBJECT TO BEING DEMOLISHED AND RECONSTRUCTED.

GENERAL CONTRACTOR RESPONSIBILITY TO SPECIAL INSPECTOR:

- PROVIDE A COPY OF THE CONSTRUCTION DOCUMENTS TO THE SPECIAL INSPECTOR.
- GIVE ADVANCED NOTICE OF WORK TO SPECIAL INSPECTOR SO THAT SCHEDULING OF PERSONNEL AND TEST MAY HAVE AMPLE TIME TO COORDINATE.
- PROVIDE SPECIAL INSPECTOR ACCESS TO WORK.
- PROVIDE STORAGE SPACE FOR THE SPECIAL INSPECTOR'S USE.
- PROVIDE LABOR TO ASSIST SPECIAL INSPECTOR.

SPECIAL INSPECTOR RESPONSIBILITIES:

- SHALL BE LICENCED PROFESSIONAL ENGINEER IN/ AND PRACTICING IN THE STATE OF TENNESSEE.
- SPECIAL INSPECTOR SHALL BE CERTIFIED TO PERFORM SUCH INSPECTIONS.
- SPECIAL INSPECTOR SHALL KEEP RECORDS OF ALL INSPECTIONS AND PROVIDE REPORTS TO THE BUILDING OFFICIAL AND THE ARCHITECT. DISCREPANCIES SHALL BE BROUGHT TO THE IMMEDIATE ATTENTION OF THE GENERAL CONTRACTOR FOR CORRECTION.
- IF CORRECTIONS ARE NOT SATISFACTORY TO THE SPECIAL INSPECTOR, THE BUILDING OFFICIAL AND THE ARCHITECT SHALL BE NOTIFIED OF THE DISCREPANCY.
- REPORT OF INSPECTIONS THAT DOCUMENT REQUIRED SPECIAL INSPECTIONS, DISCREPANCIES, AND CORRECTIONS SHALL BE SUBMITTED TO THE GENERAL CONTRACTOR AND ARCHITECTS FOLLOWING EACH INSPECTION.


SPECIAL INSPECTIONS:

CAST-IN-PLACE CONCRETE


- MANUFACTURER'S DATA FOR TENSILE AND COMPRESSIVE SPICES SHALL BE SUBMITTED.
- ESTABLISH CONCRETE MIX DESIGN PROPORTIONS PER ACI 318, CH. 5. SUBMIT CONCRETE MIX DESIGN TO INCLUDE: TYPE AND QUANTITY OF MATERIALS, SLUMP, AIR CONTENT, FRESH UNIT WEIGHT, AGGREGATES DESIGN COMPRESSIVE STRENGTH, LOCATION OF PLACEMENT STRUCTURE, METHOD OF PLACEMENT, METHOD OF CURING, SEVEN-DAY AND 28-DAY COMPRESSIVE STRENGTHS.
- CERTIFICATION STATING MATERIALS MEET THE REQUIREMENTS OF THE SPECIFICATION ASTM AND ACI STANDARDS MUST BE SUBMITTED FROM EACH MANUFACTURE.
- CERTIFICATION FROM THE READY-MIXED CONCRETE PLANT MUST BE SUBMITTED SHOWING PLAN COMPLIES WITH THE REQUIREMENTS OF THE NATIONAL READY-MIX CONCRETE ASSOCIATION.

THE FOLLOWING SHALL BE PERFORMED BY THE SPECIAL INSPECTOR:


- VERIFY GRADE, QUANTITY, LOCATION, AND PLACEMENT OF THE REINFORCING STEEL PRIOR TO CONCRETE PLACEMENT.
- EXAMINE CONCRETE IN TRUCK TO VERIFY CONCRETE APPEARS PROPERLY MIXED.
- PERFORM A SLUMP TEST AS DEEMED NECESSARY FOR EACH CONCRETE LOAD. RECORD IF WATER OR ADMIXTURES ARE ADDED TO THE CONCRETE AT THE JOB SITE. PERFORM ADDITIONAL SLUMP TEST AFTER JOB SITE ADJUSTMENTS.
- INSPECT SIZE, POSITIONING AND EMBEDMENT OF ANCHOR RODS. INSPECT CONCRETE PLACEMENT AND CONSOLIDATION AROUND ANCHORS.
- INSPECT PLACEMENT OF CONCRETE. VERIFY THAT CONCRETE CONVEYANCE AND DEPOSITING AVOIDS SEGREGATION OR CONTAMINATION. VERIFY THAT CONCRETE IS PROPERLY CONSOLIDATED.
- INSPECT CURING, COLD WEATHER PROTECTION AND HOT WEATHER PROTECTION PROCEDURES.
- MOLD FIVE SPECIMENS PER SET FOR COMPRESSION STRENGTH TESTING; ONE SET FOR EACH 50 CUBIC YARDS OF EACH MIX DESIGN PLACED IN ANY ONE DAY. RECORD THE FOLLOWING FOR EACH SET MOLDED: SLUMP, AIR CONTENT, UNIT WEIGHT, TEMPERATURE (AMBIENT AND CONCRETE), LOCATION OF PLACEMENT, ANY PERTINENT INFORMATION. PERFORM ONE 7-DAY AND TWO 28-DAY COMPRESSIVE STRENGTH TEST.
- COMPRESSIVE TEST REPORTS SHALL CONTAIN PROJECT NAME AND NUMBER, CONCRETE PLACEMENT DATE, TESTING AGENCY NAME, CONCRETE DESIGN COMPRESSIVE STRENGTH, PLACEMENT LOCATION, TYPE OF BREAK, AND COMPRESSIVE BREAKING STRENGTH.

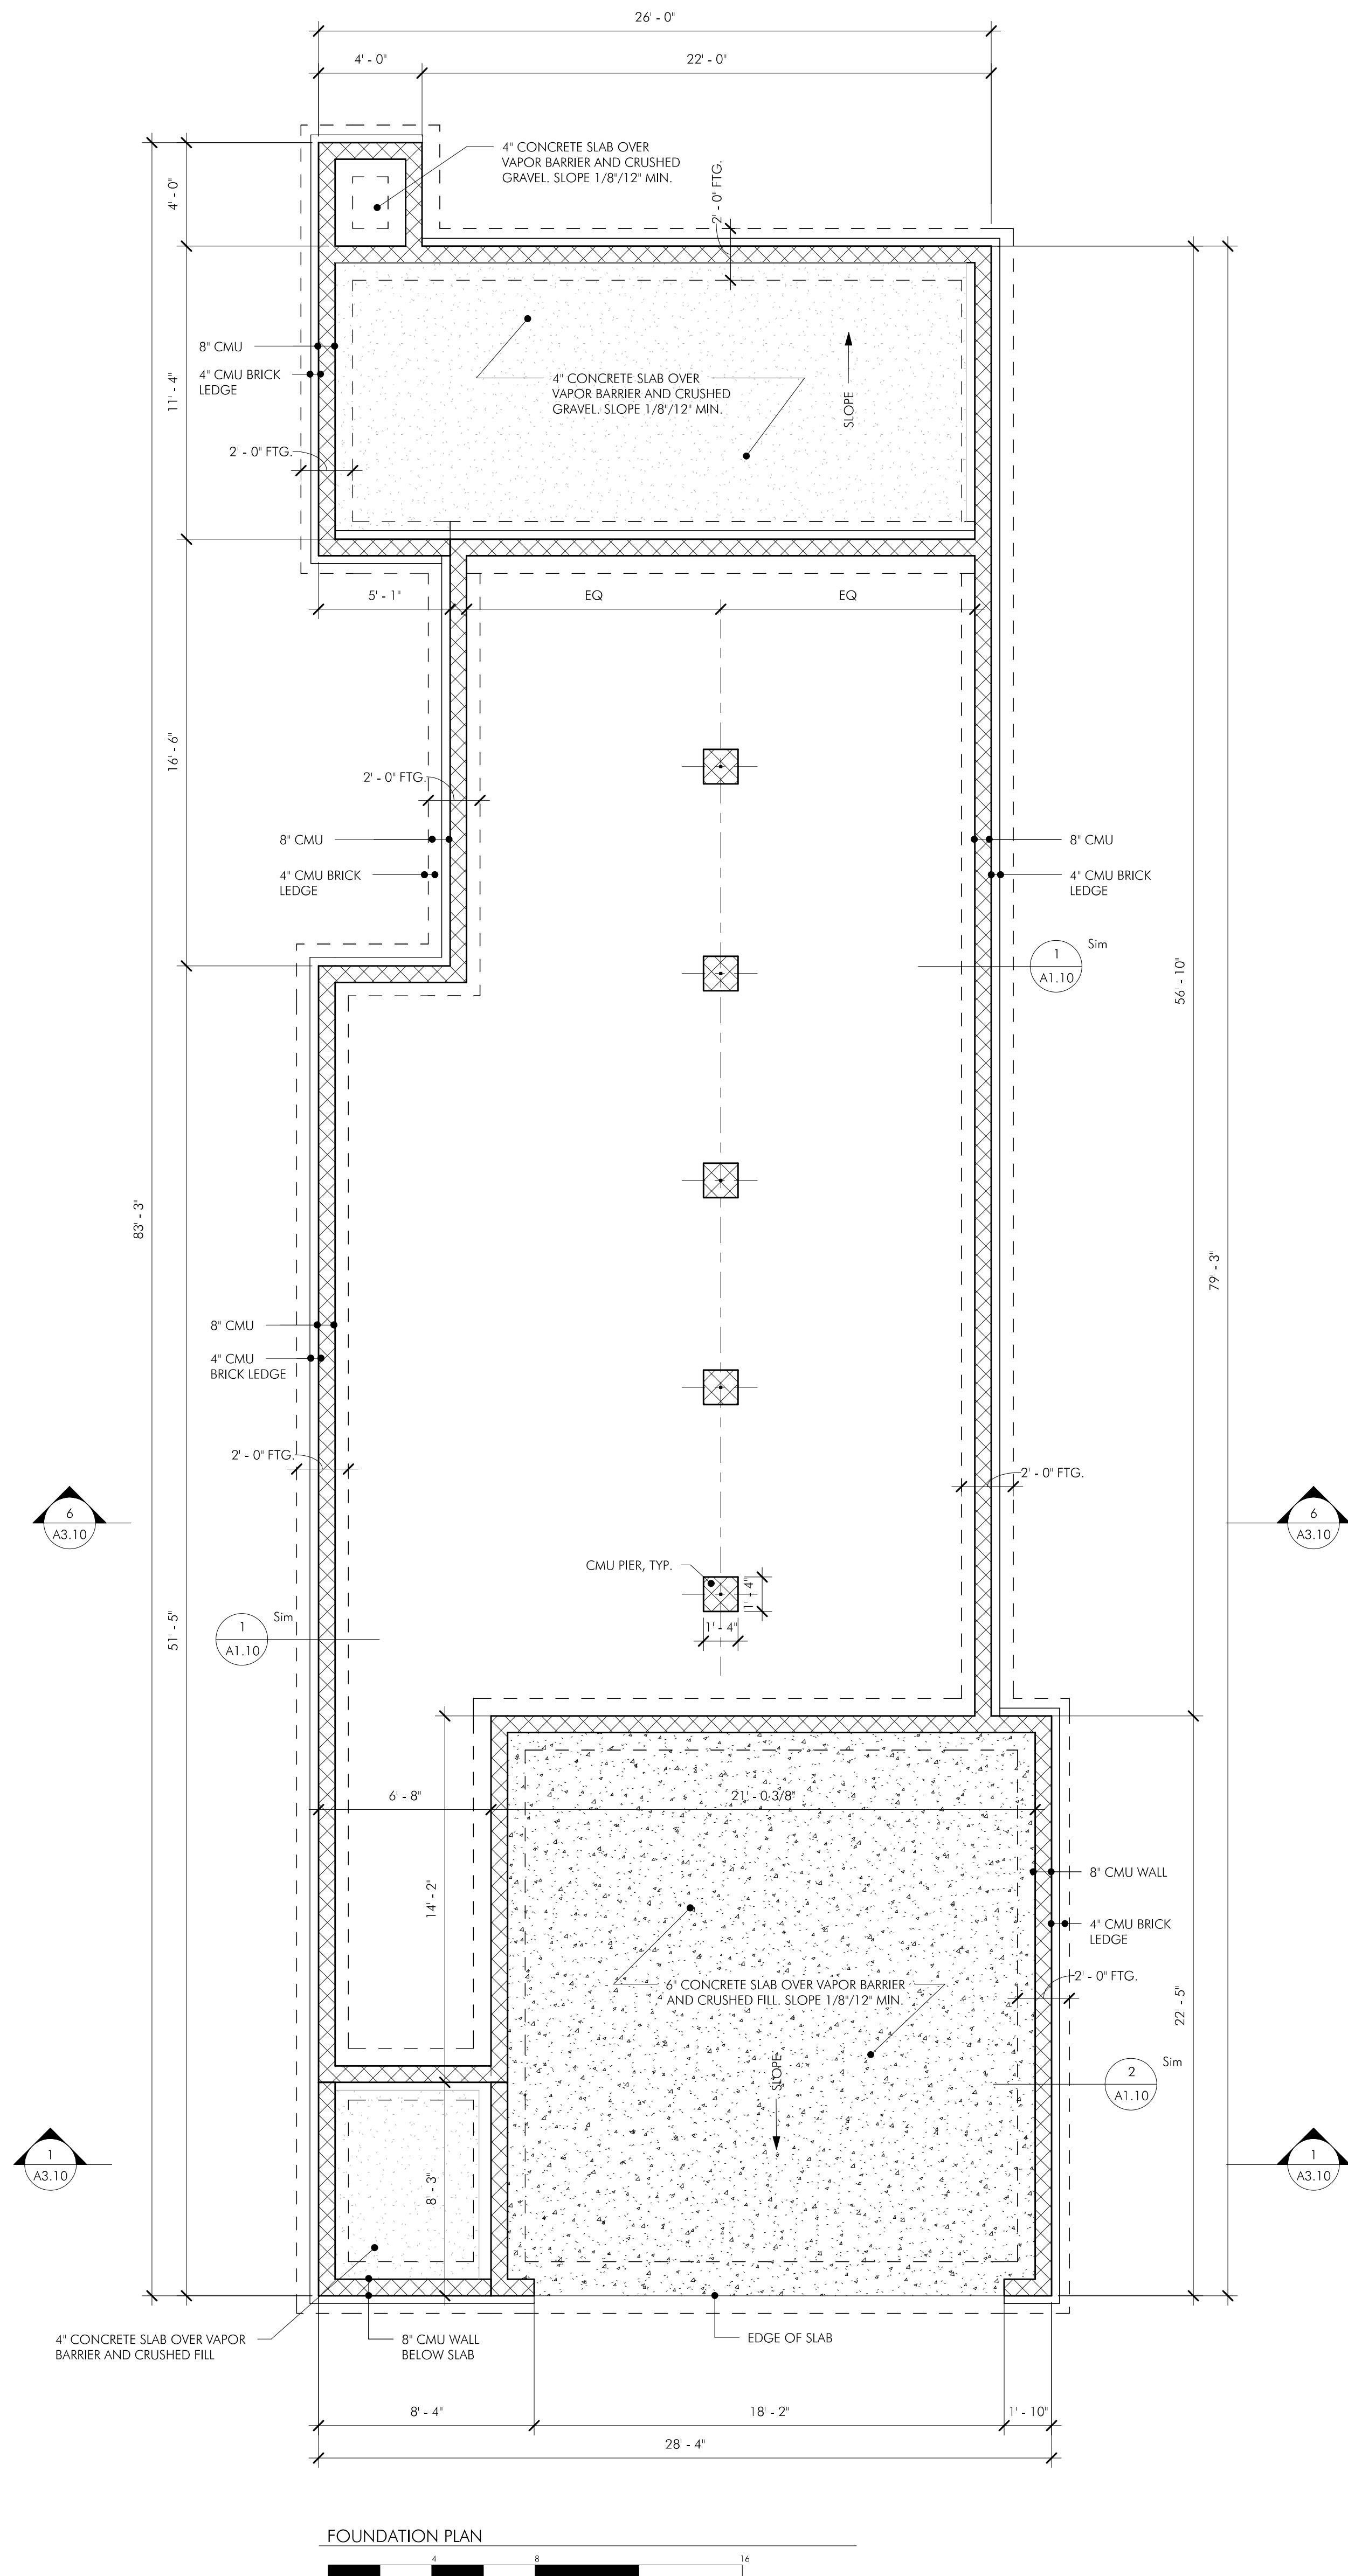


FOUNDATION PLAN
1 1/2" = 1'-0"

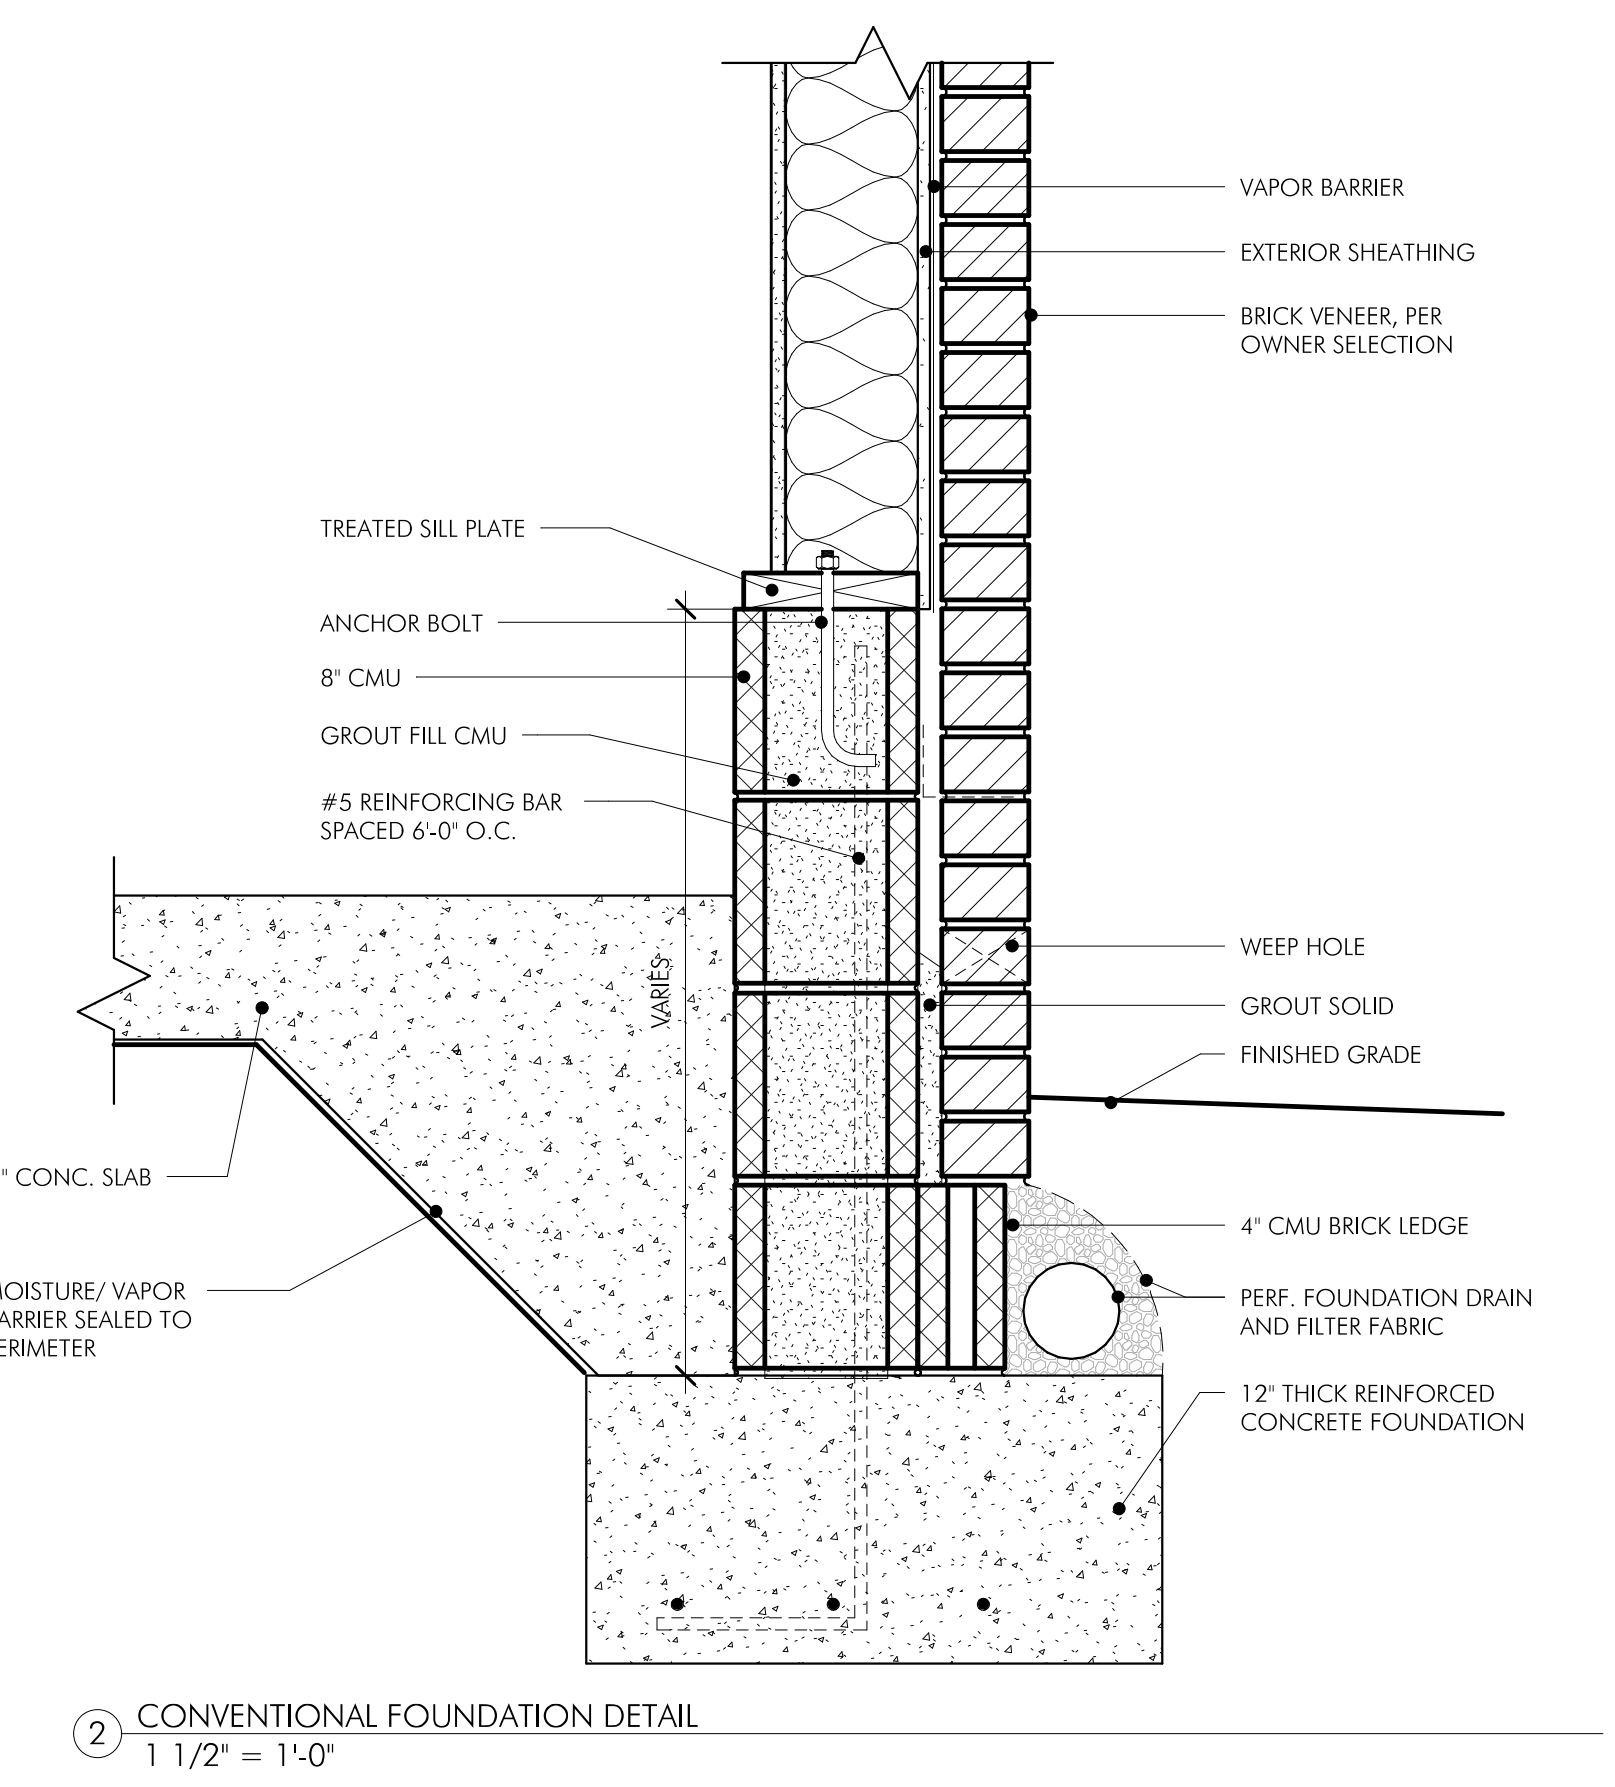

CONVENTIONAL FOUNDATION DETAIL
1 1/2" = 1'-0"

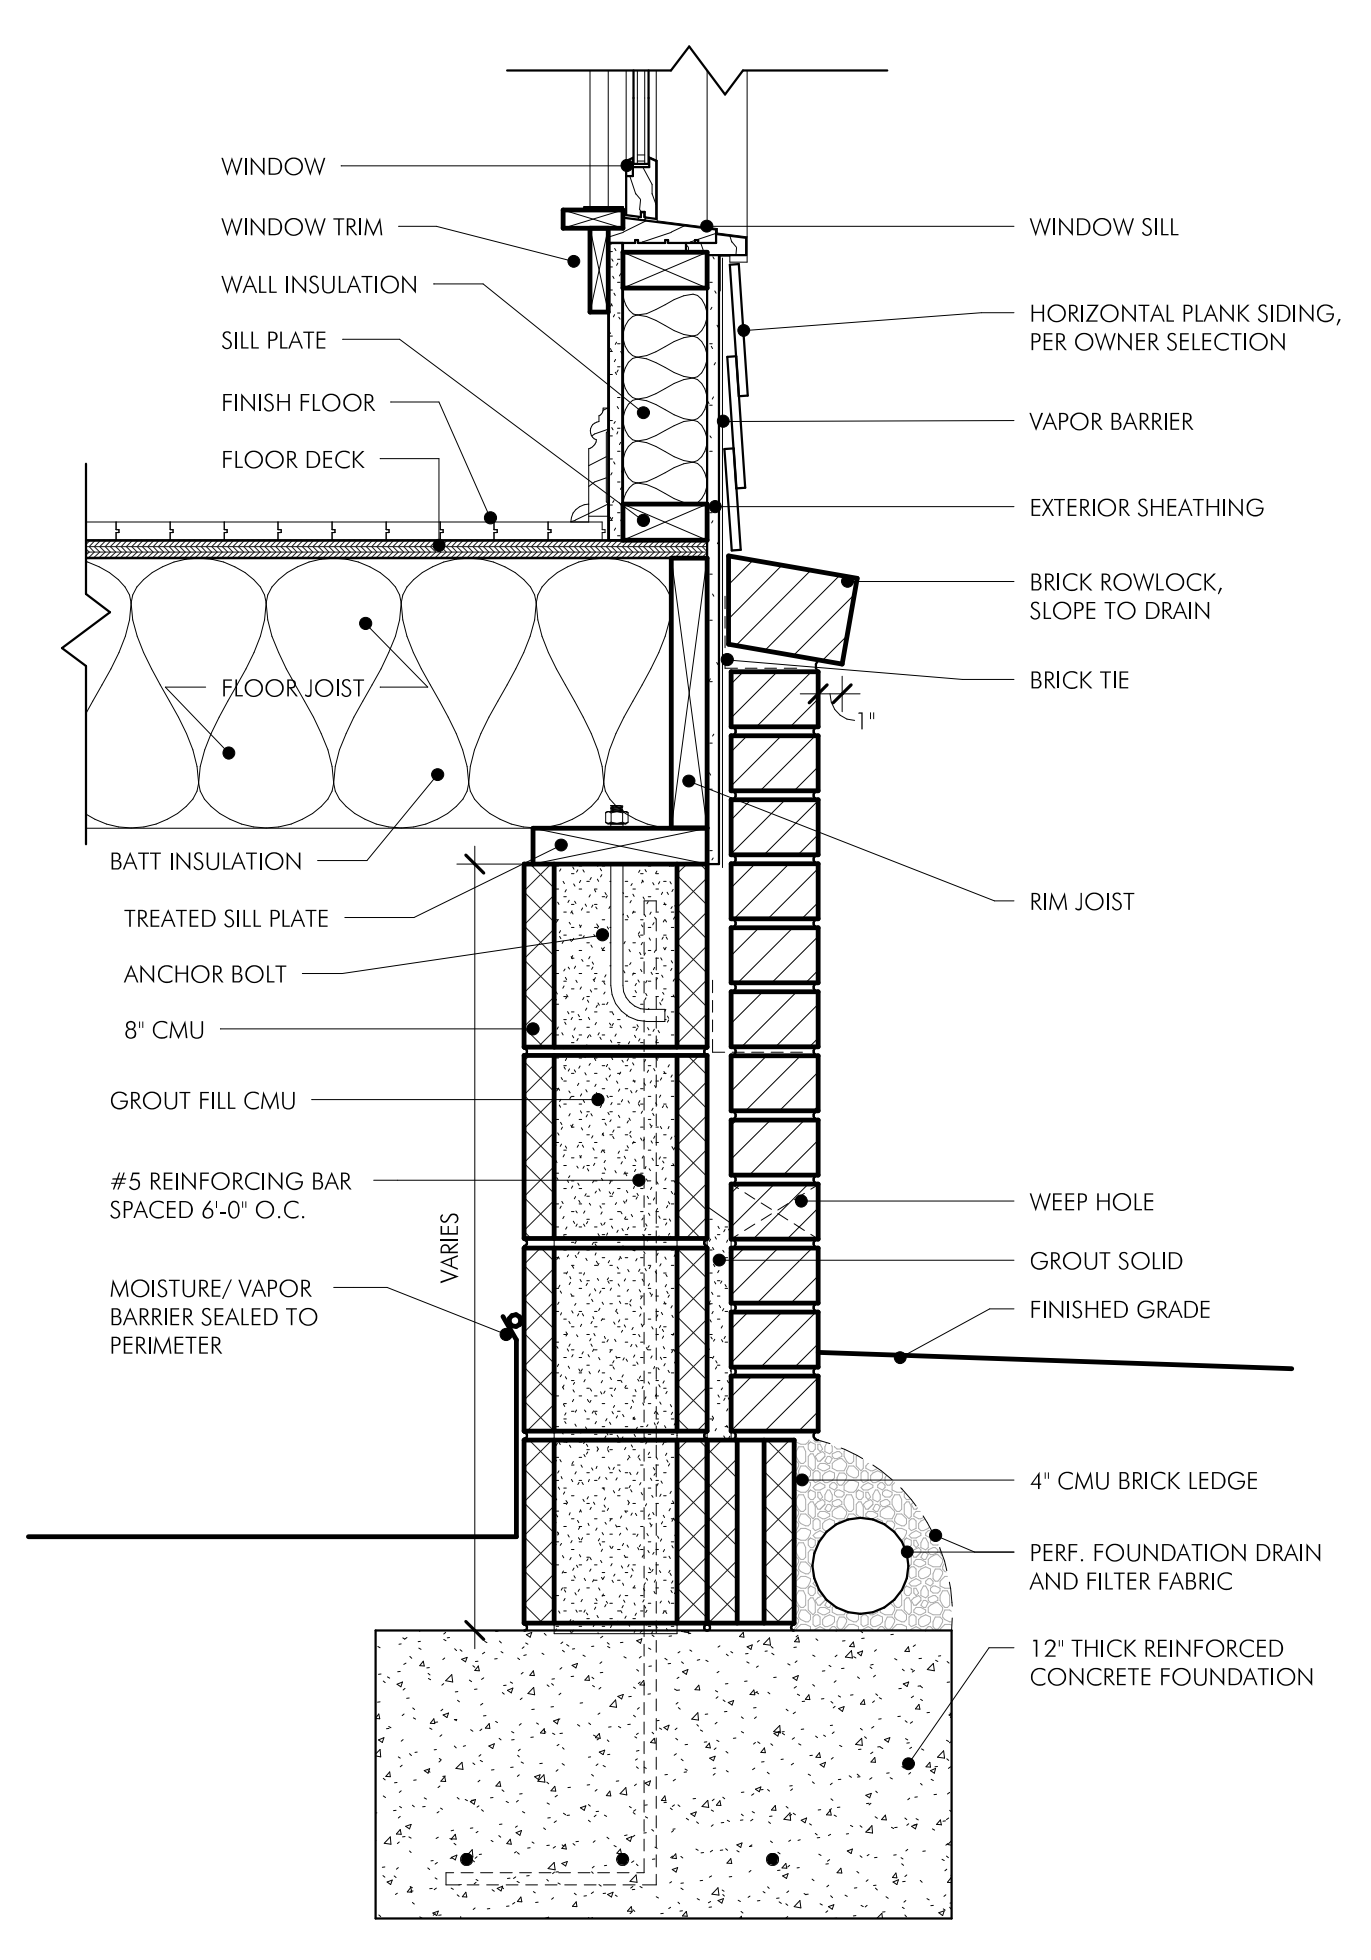

CONVENTIONAL FOUNDATION DETAIL
1 1/2" = 1'-0"

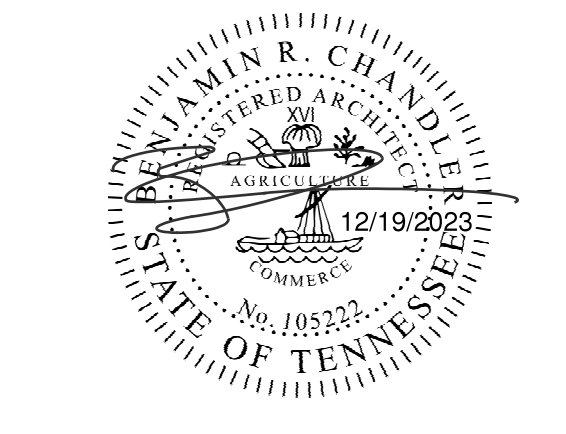

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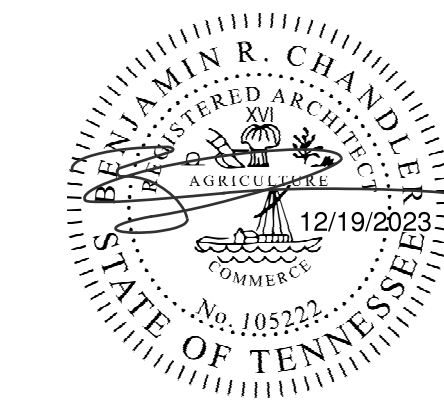
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MCH Construction of TN
515A Continental Drive
Nashville, TN 37209

PROJECT No. 23205A
DATE: 2023.12.19
REV DATE:




SHEET NAME
FOUNDATION PLAN

SHEET NUMBER
A1.10



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ELEVATION MATERIAL LEGEND	
	BRICK VENEER (COLOR: TBD BY OWNER)
	LAP SIDING (COLOR: TBD BY OWNER)
	SHINGLED ROOF (COLOR: TBD BY OWNER)
	BRICK ROWLOCK (COLOR: TBD BY OWNER)
	BRICK SOLDIER COURSE (COLOR: TBD BY OWNER)

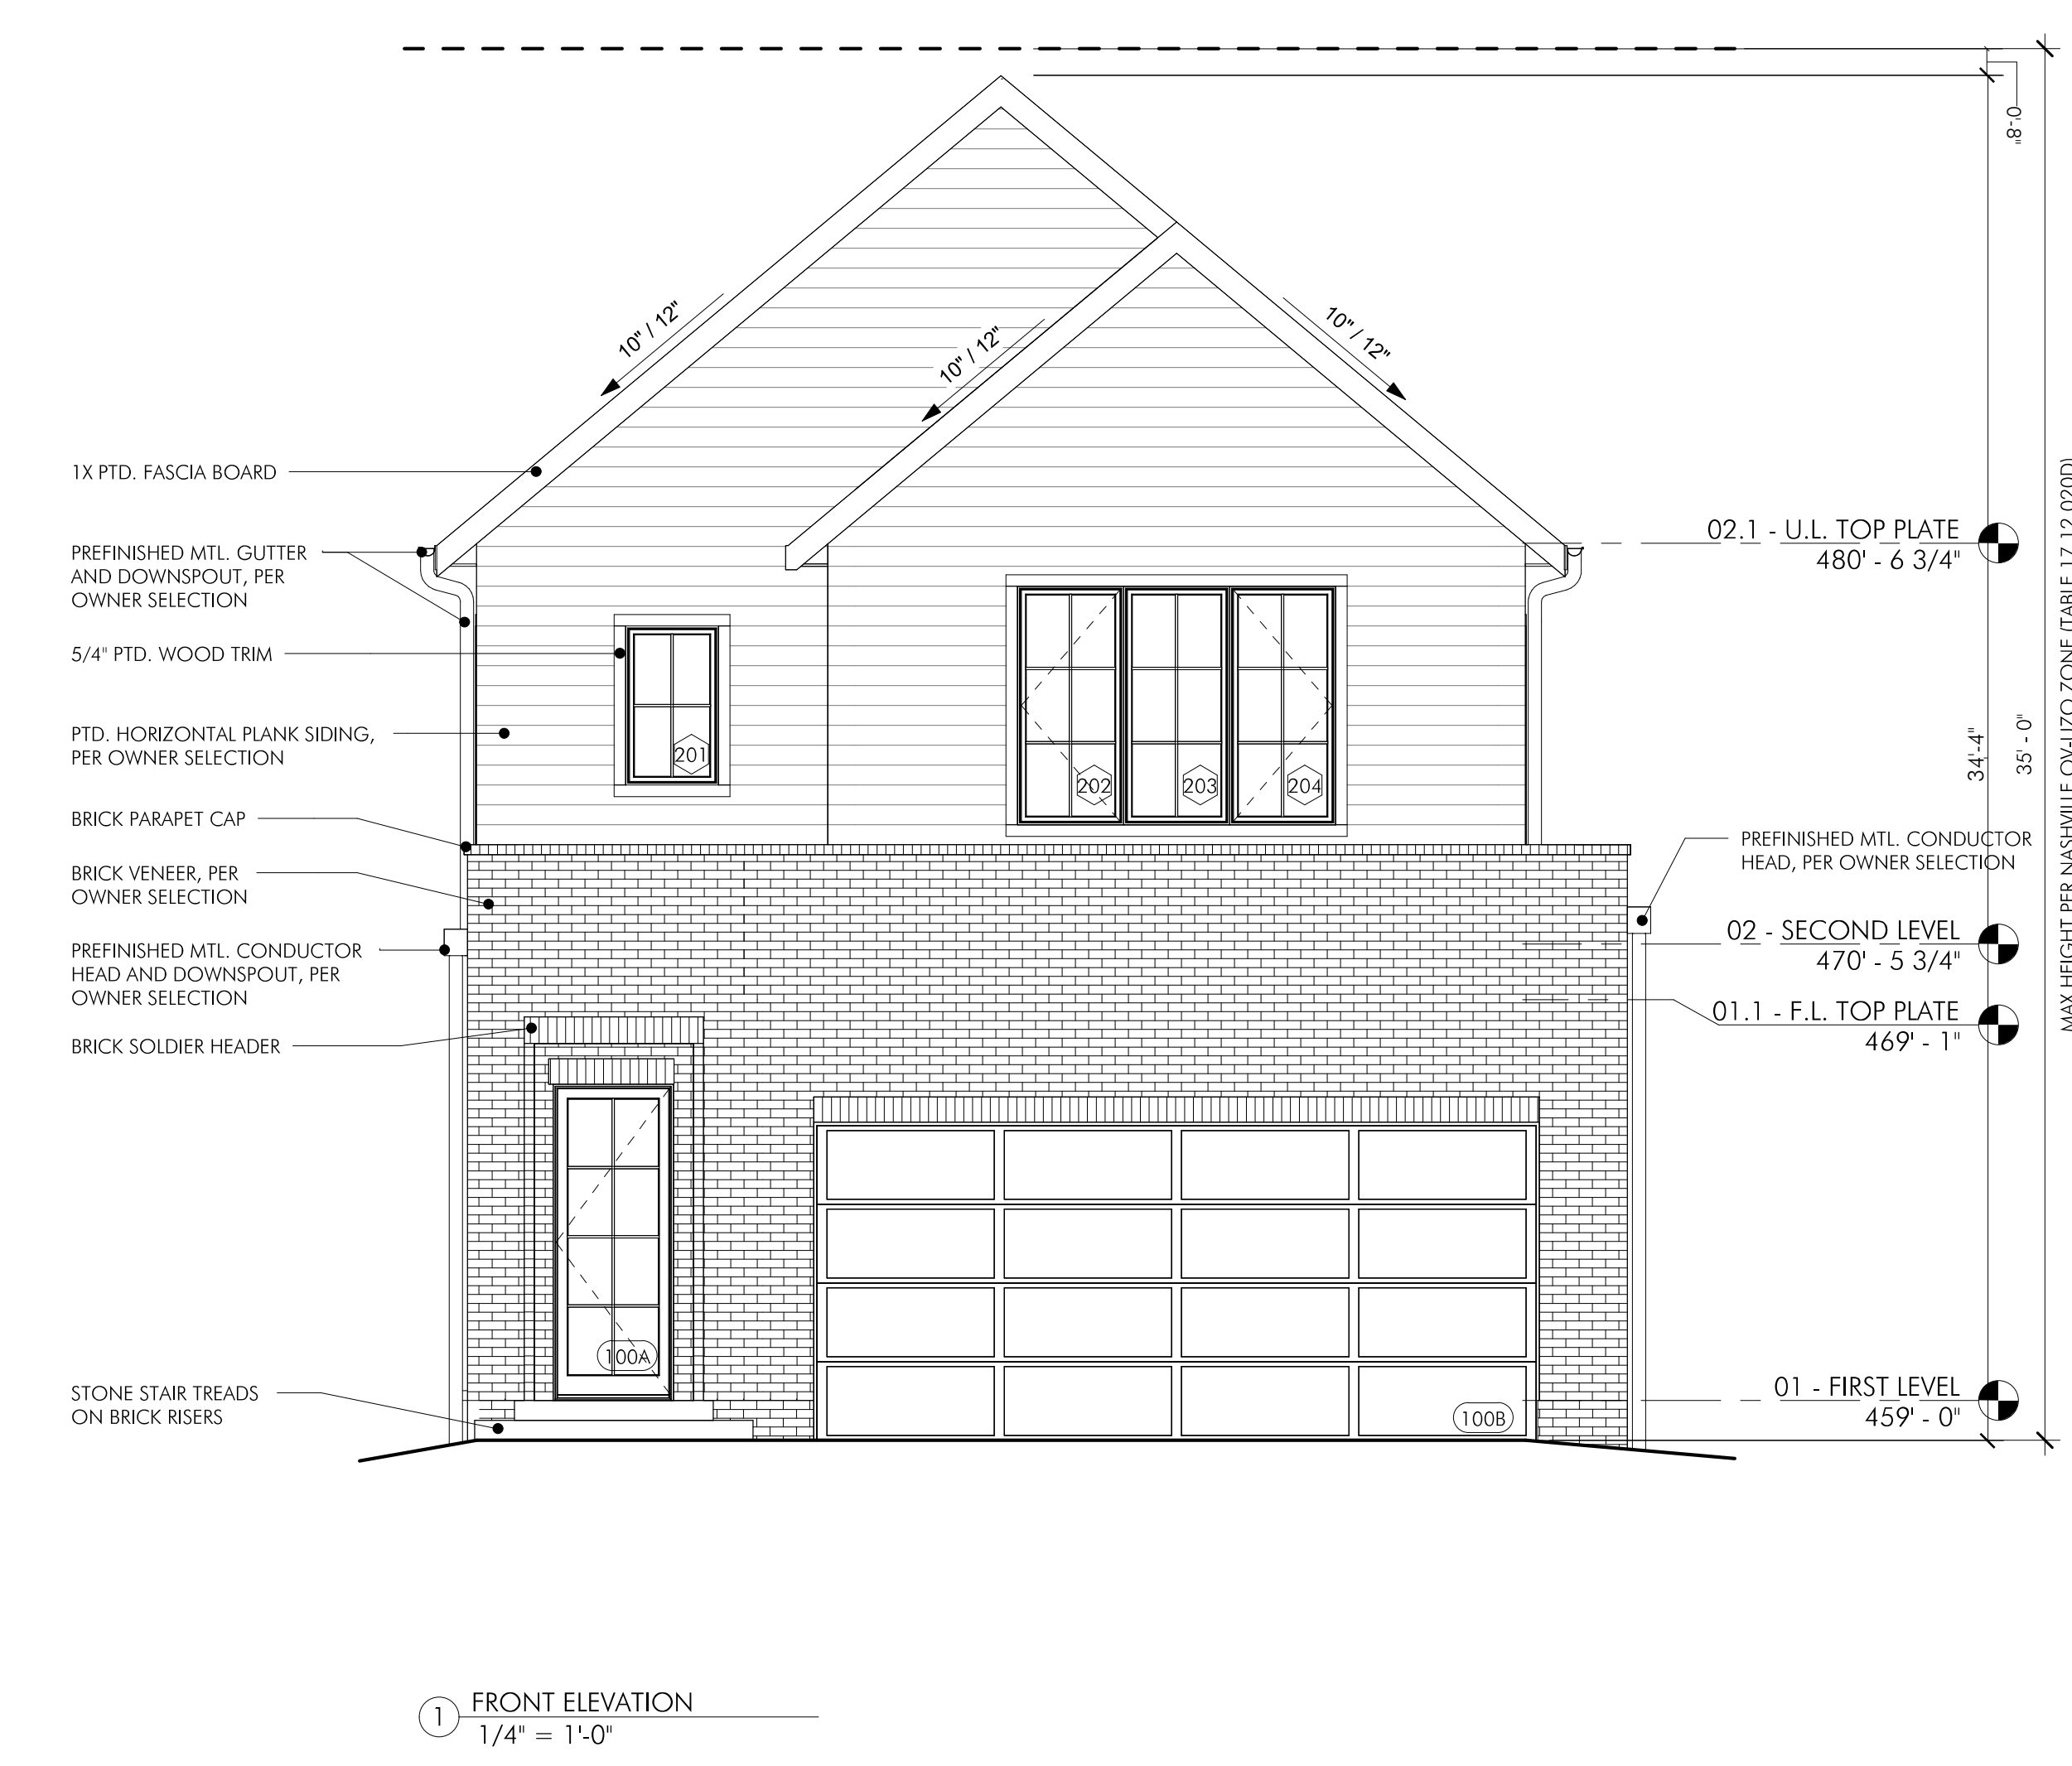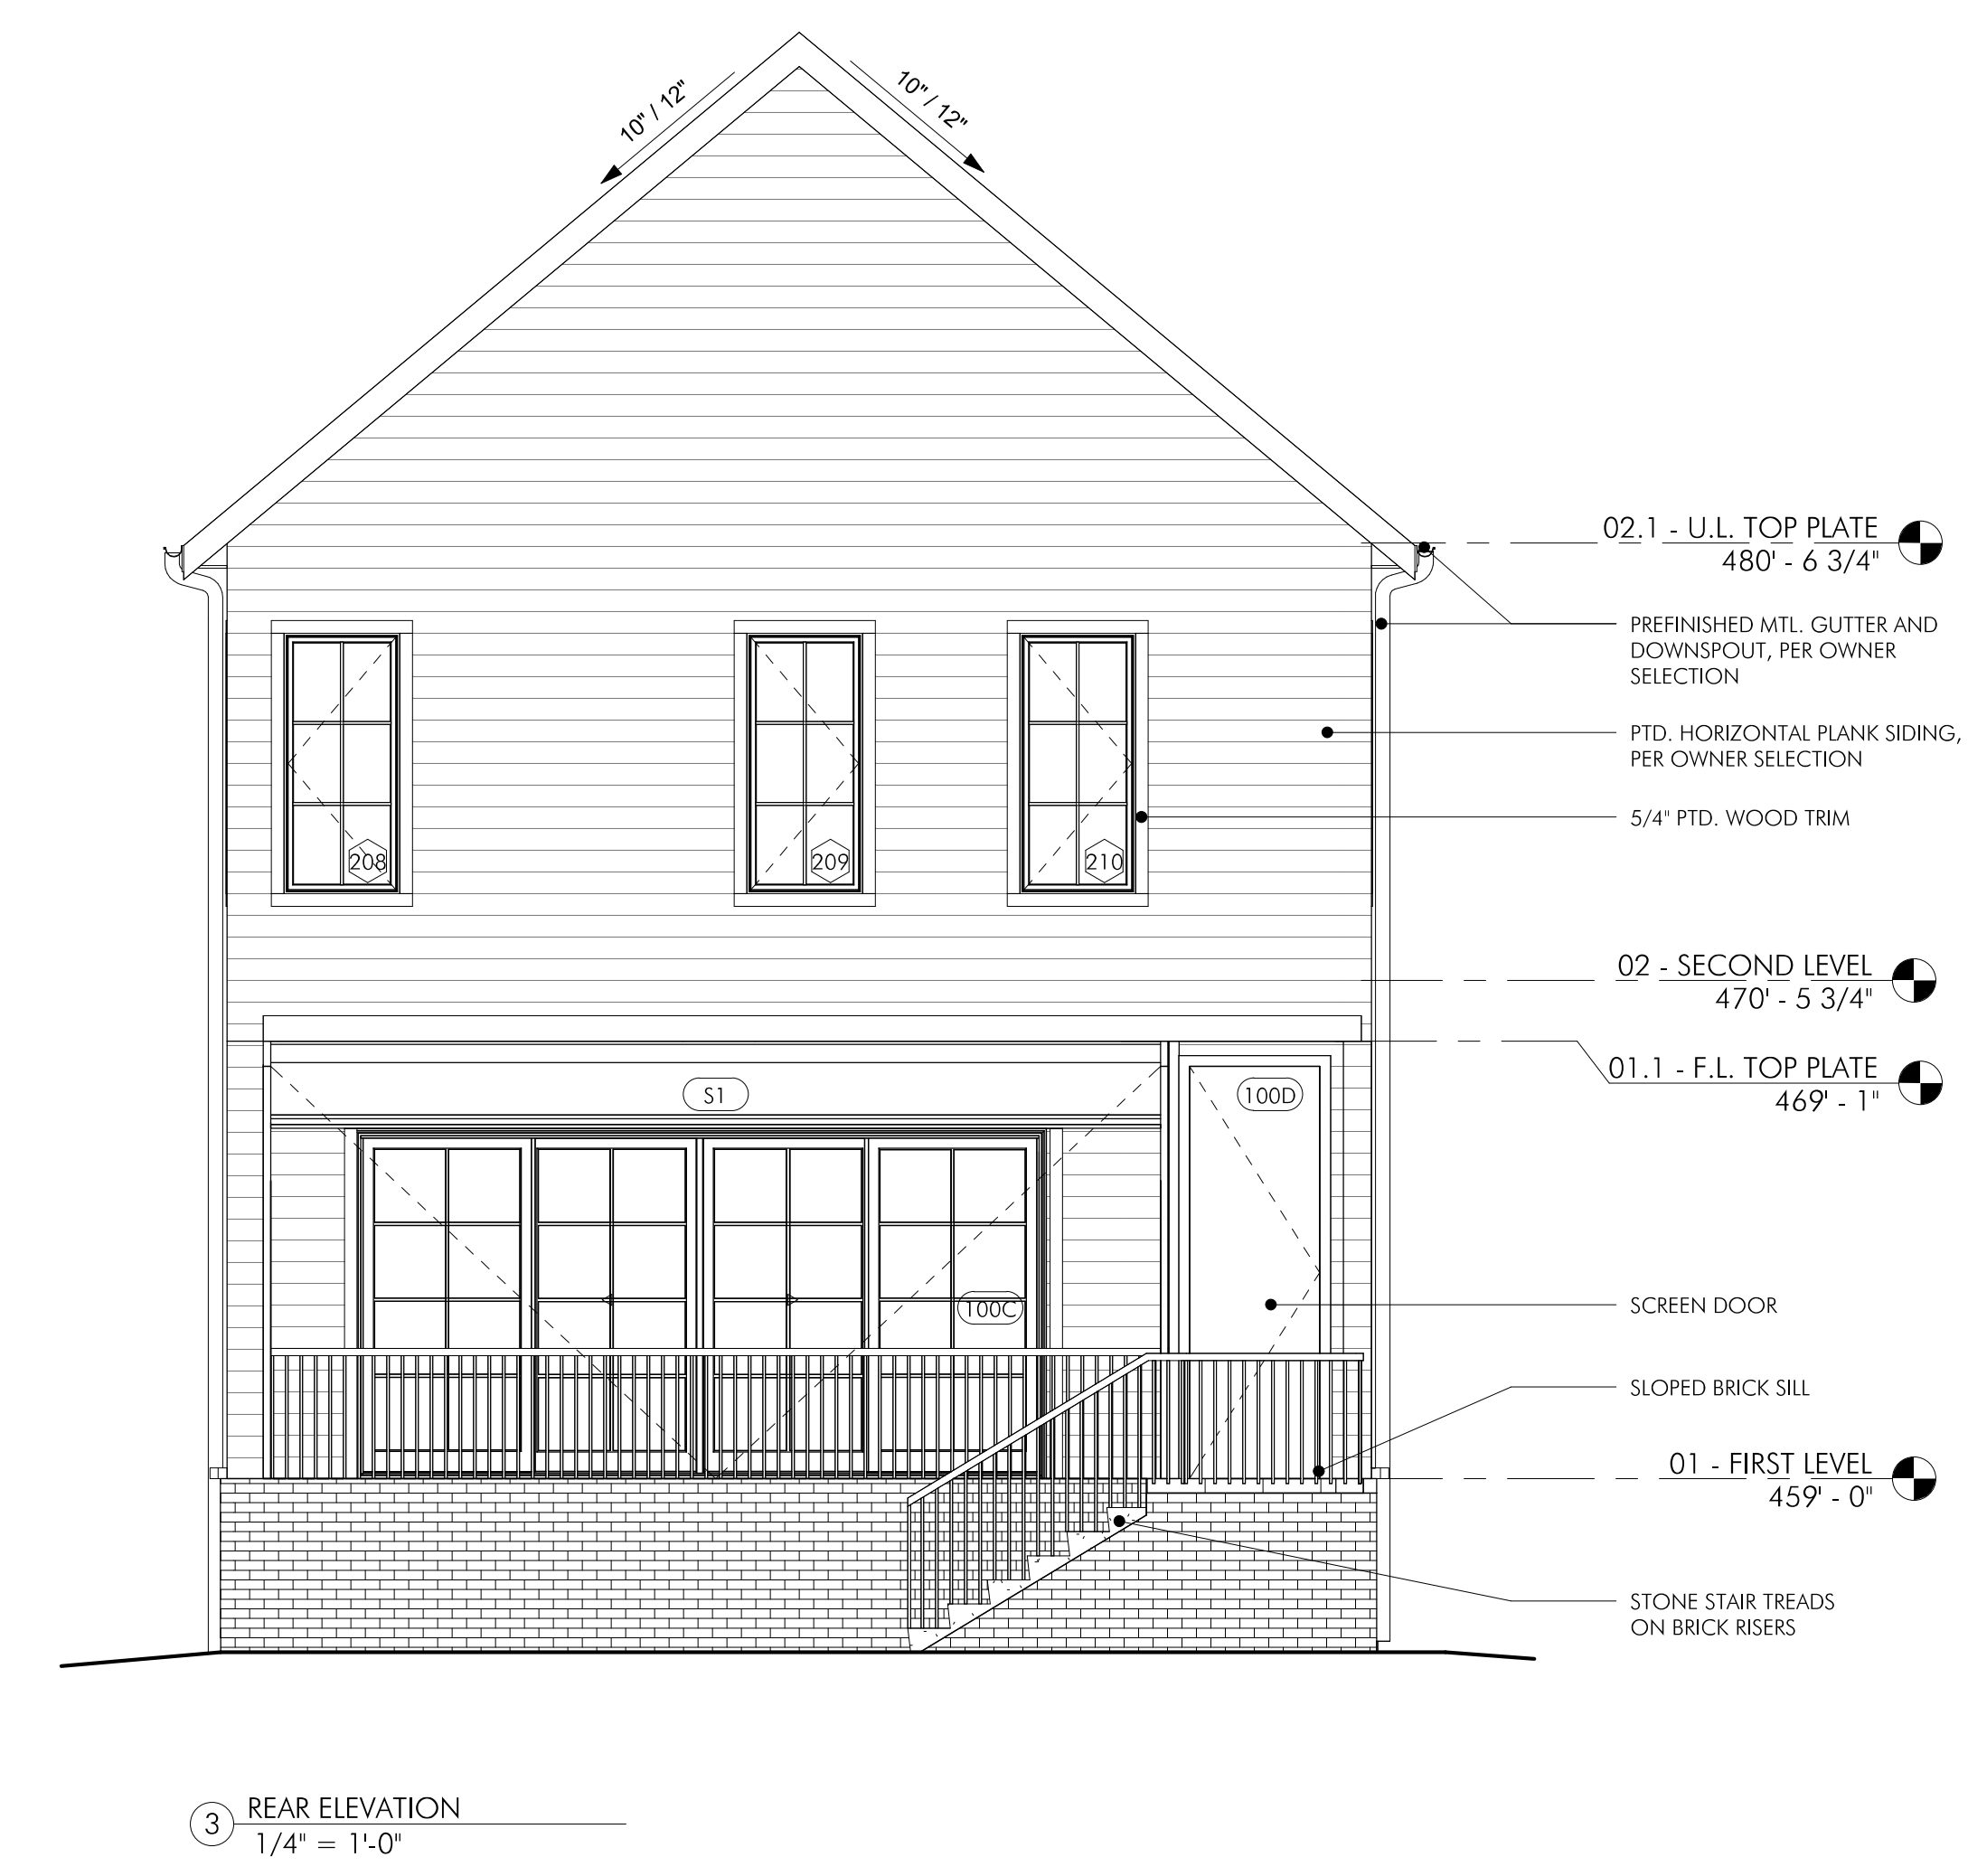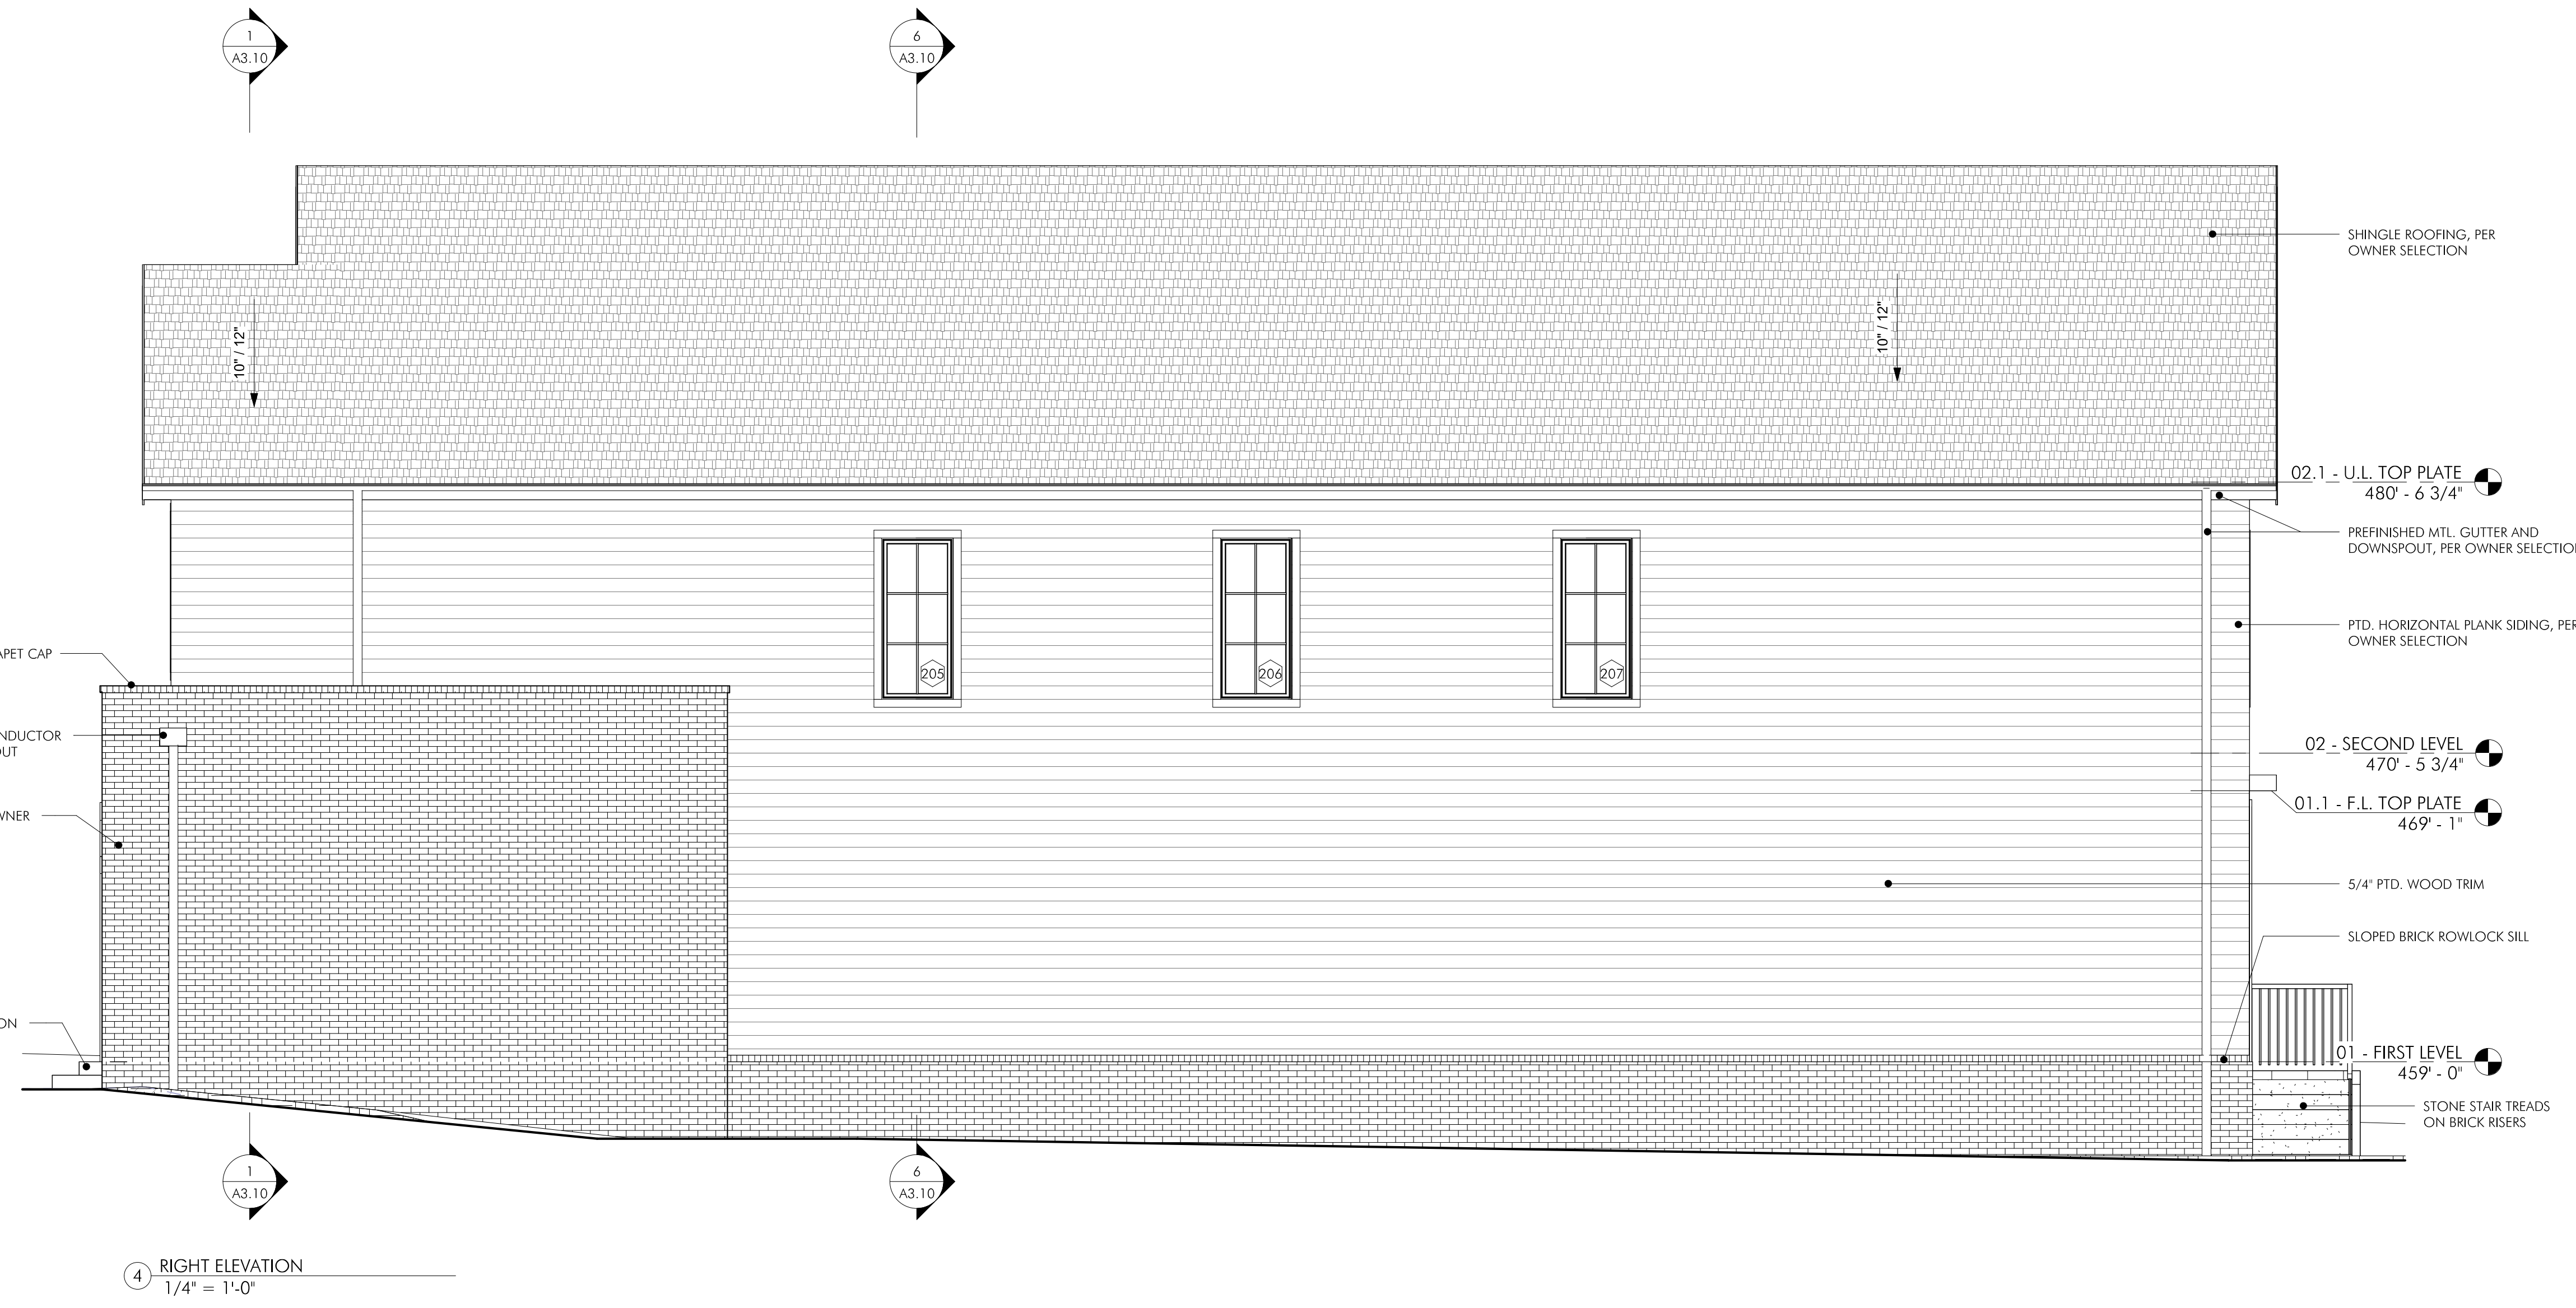


New Residence for:
MCH Construction of TN


PROJECT No. 23205A
DATE: 2023.12.19
REV DATE:

SHEET NAME
BUILDING ELEVATIONS


SHEET NUMBER
A2.10

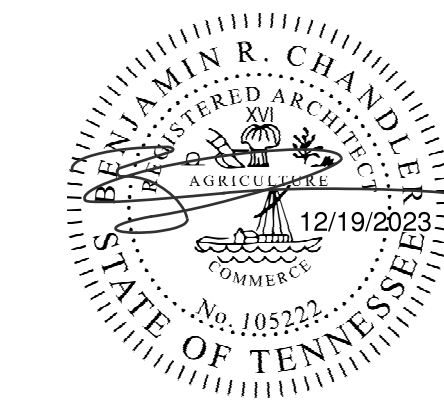


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Do Not Scale Drawings.
Contractor must verify all dimensions prior to construction.

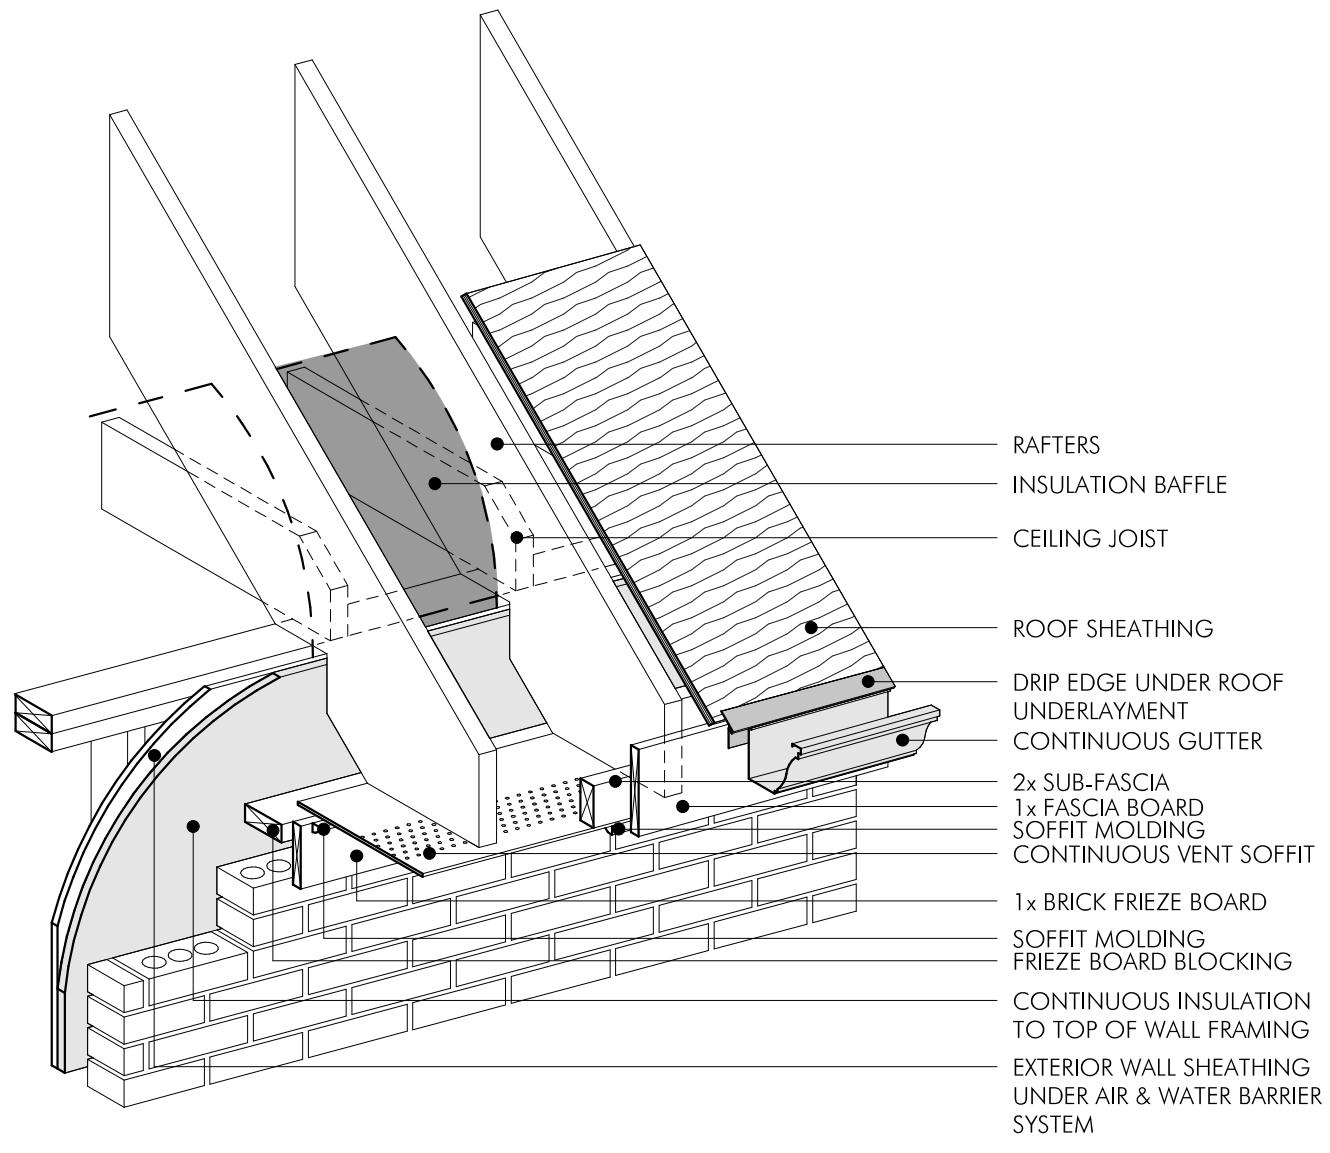


5 BRICK AT TOP OF WALL
3/4" = 1'-0"

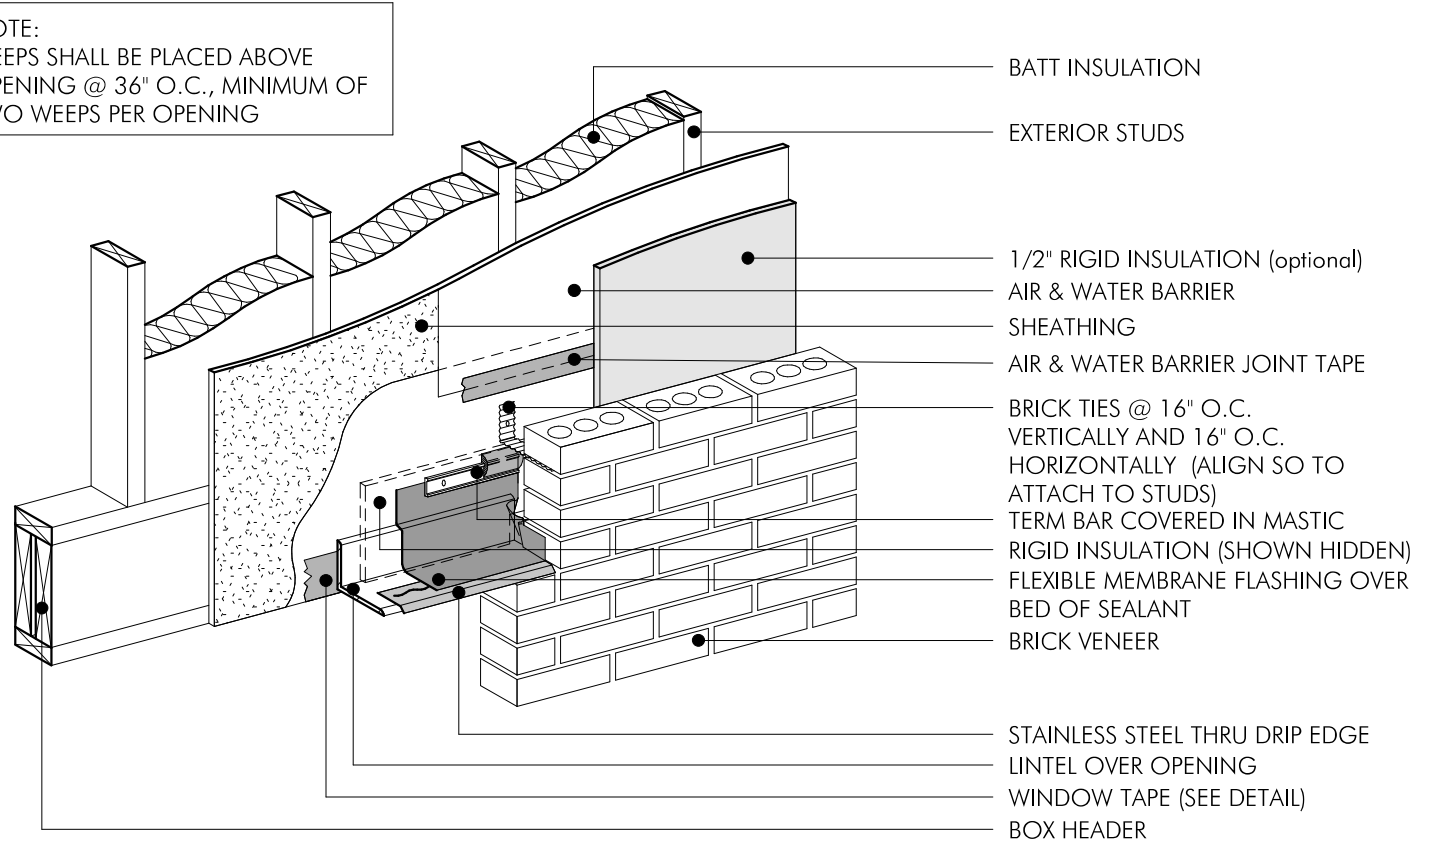


4 BRICK ABOVE OPENING
3/4" = 1'-0"

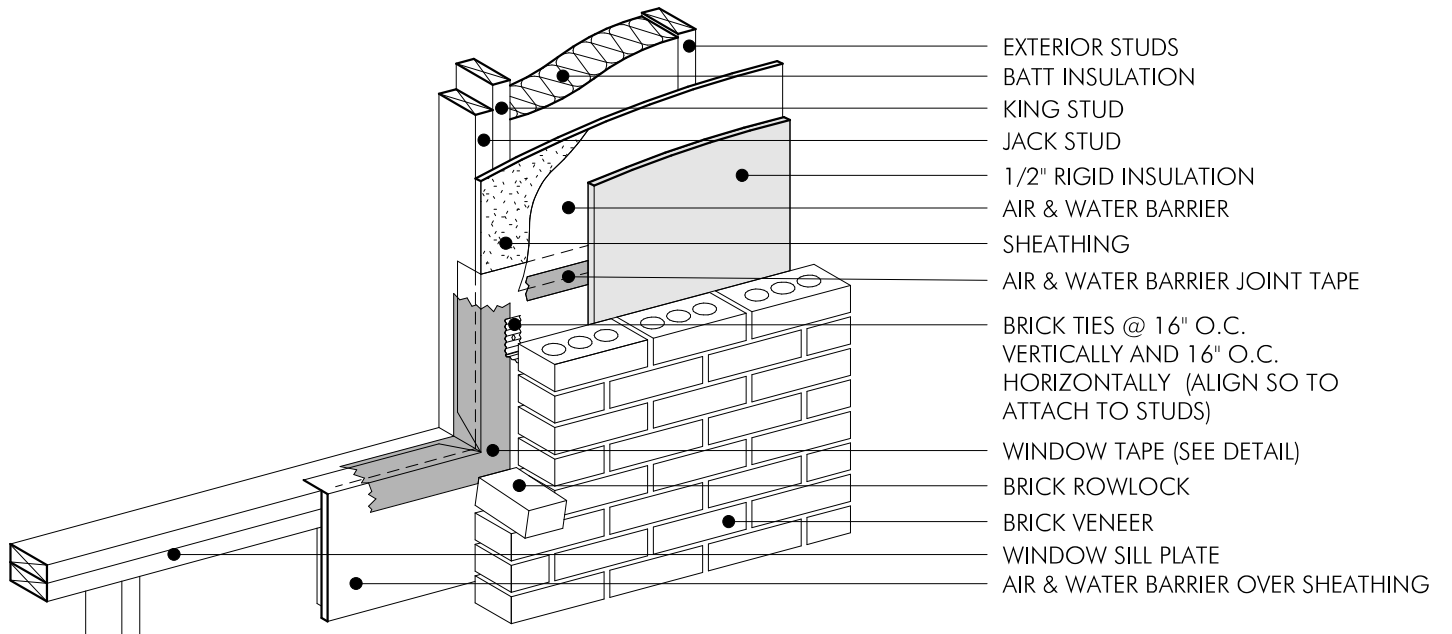


3 BRICK AT SILL
3/4" = 1'-0"

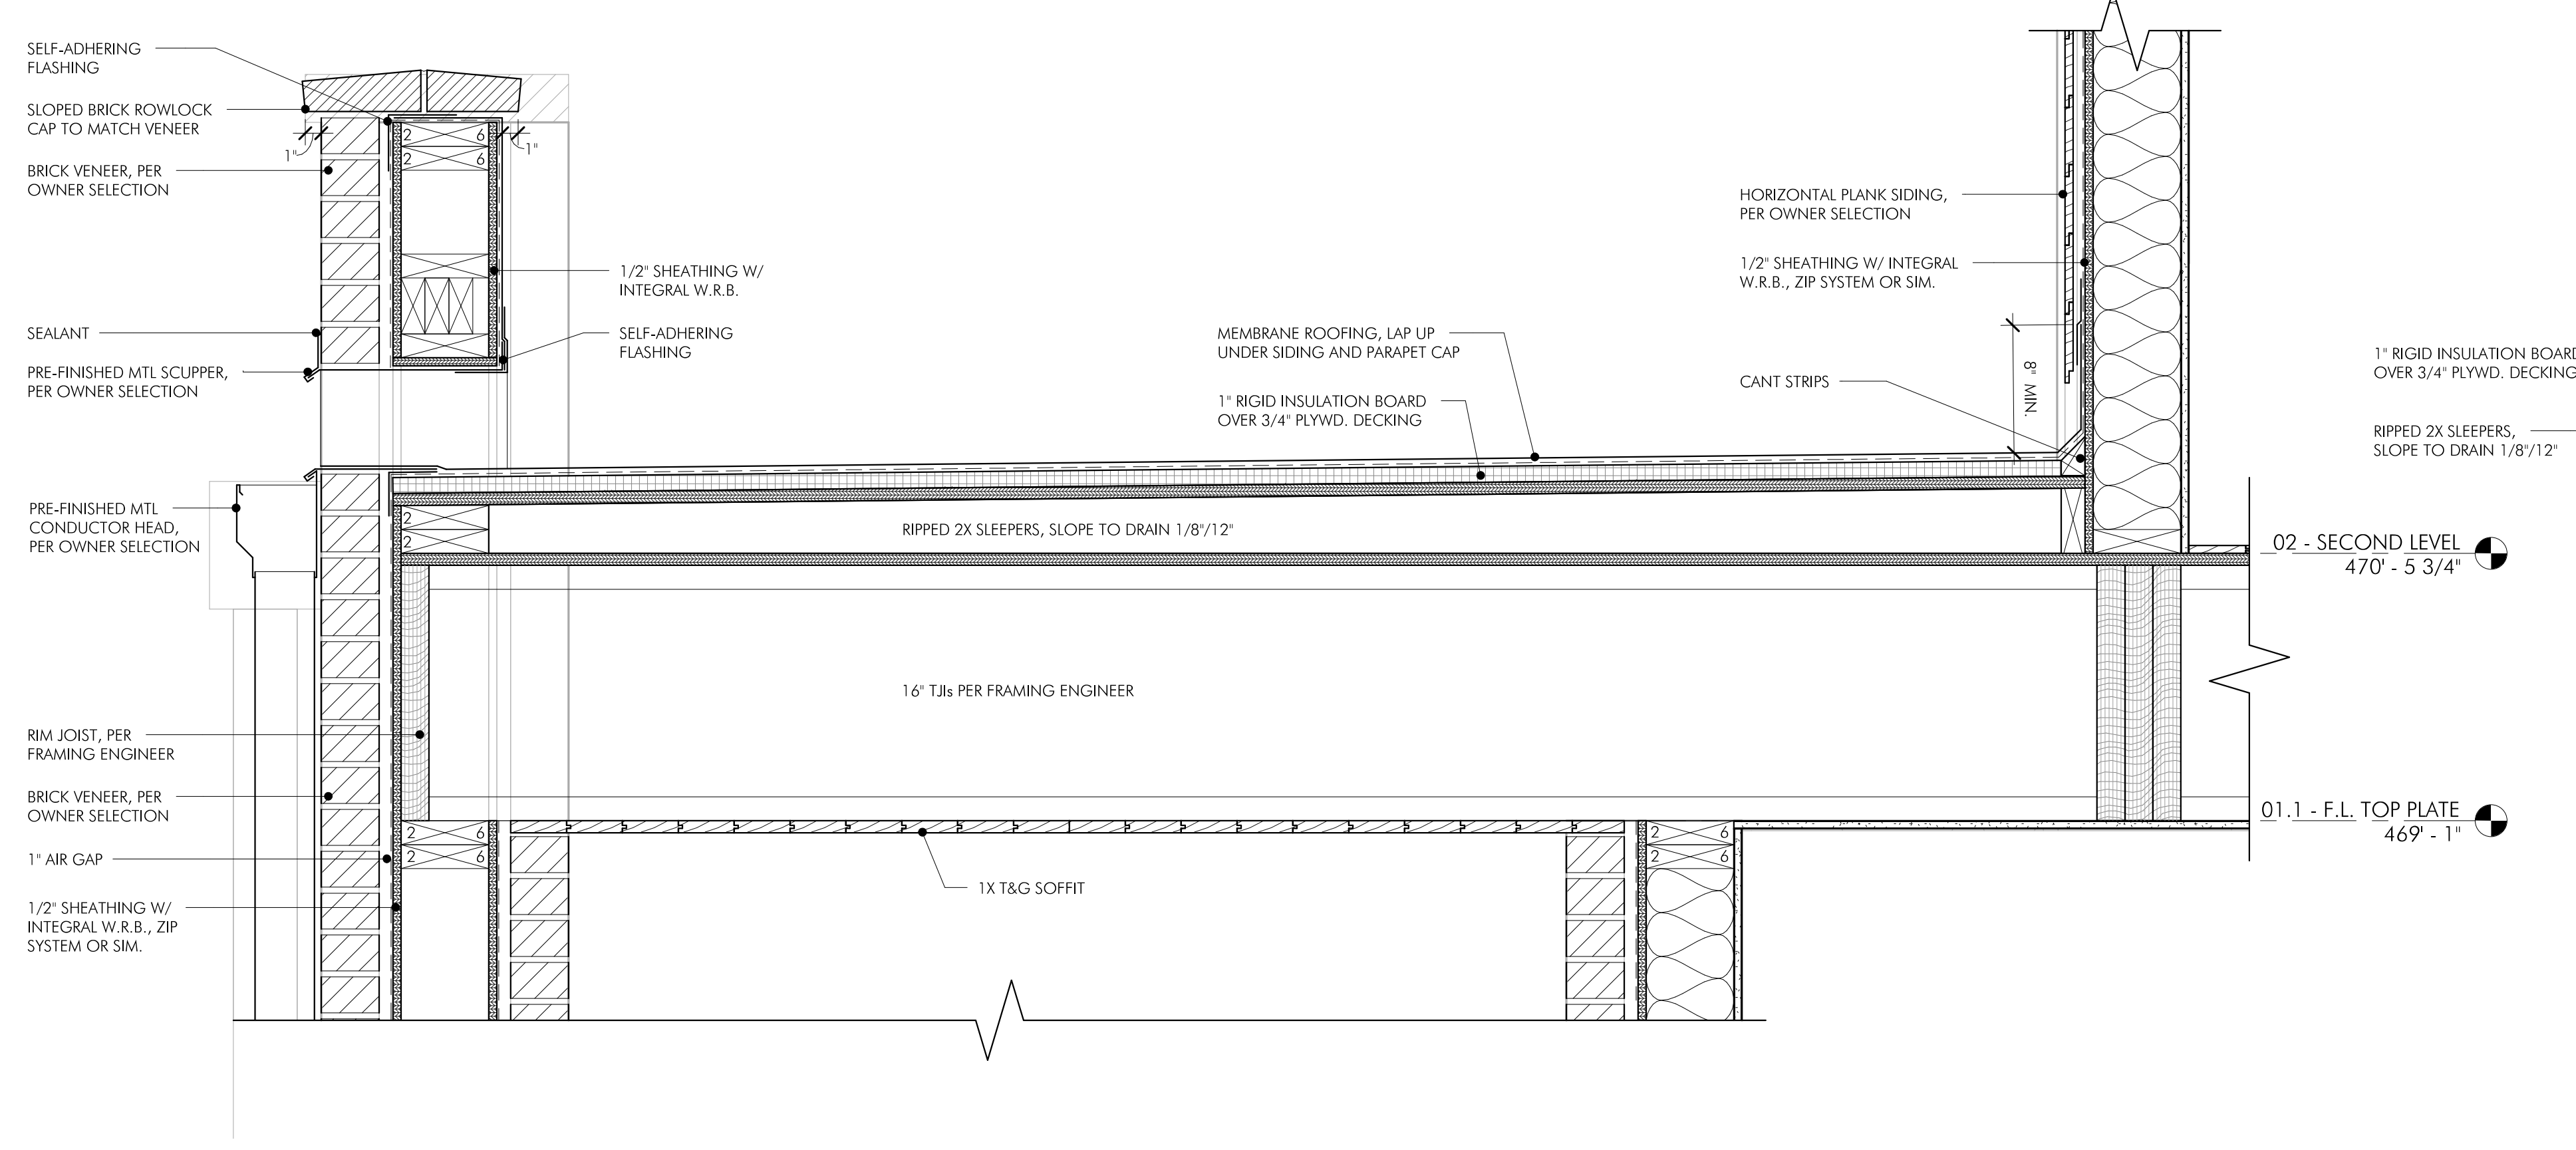


9 PARAPET DETAIL 02
1 1/2" = 1'-0"

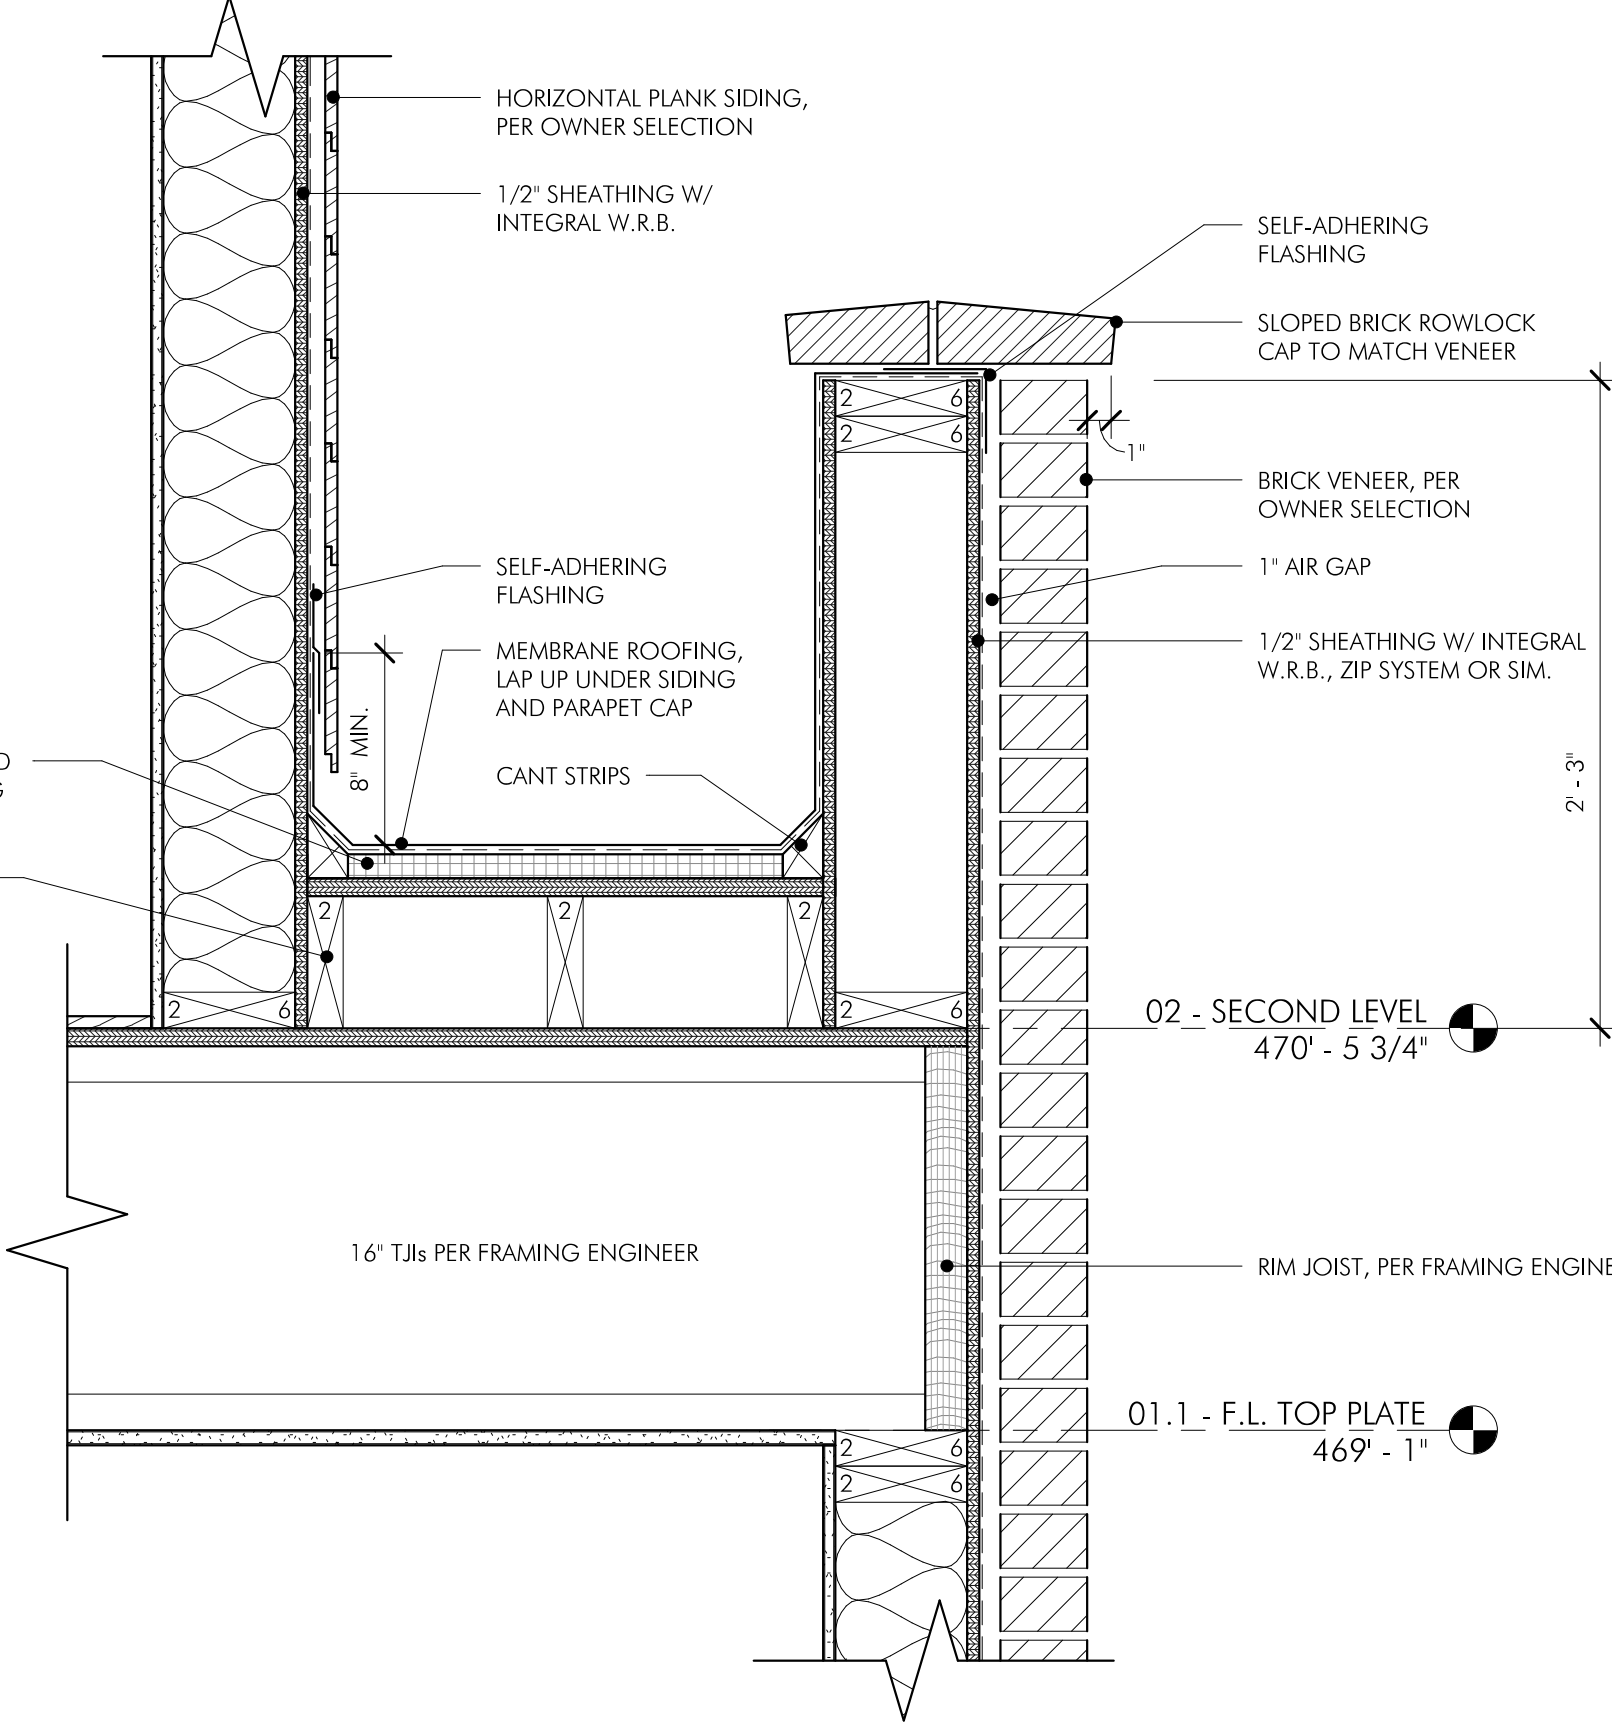


8 PARAPET DETAIL 01
1 1/2" = 1'-0"

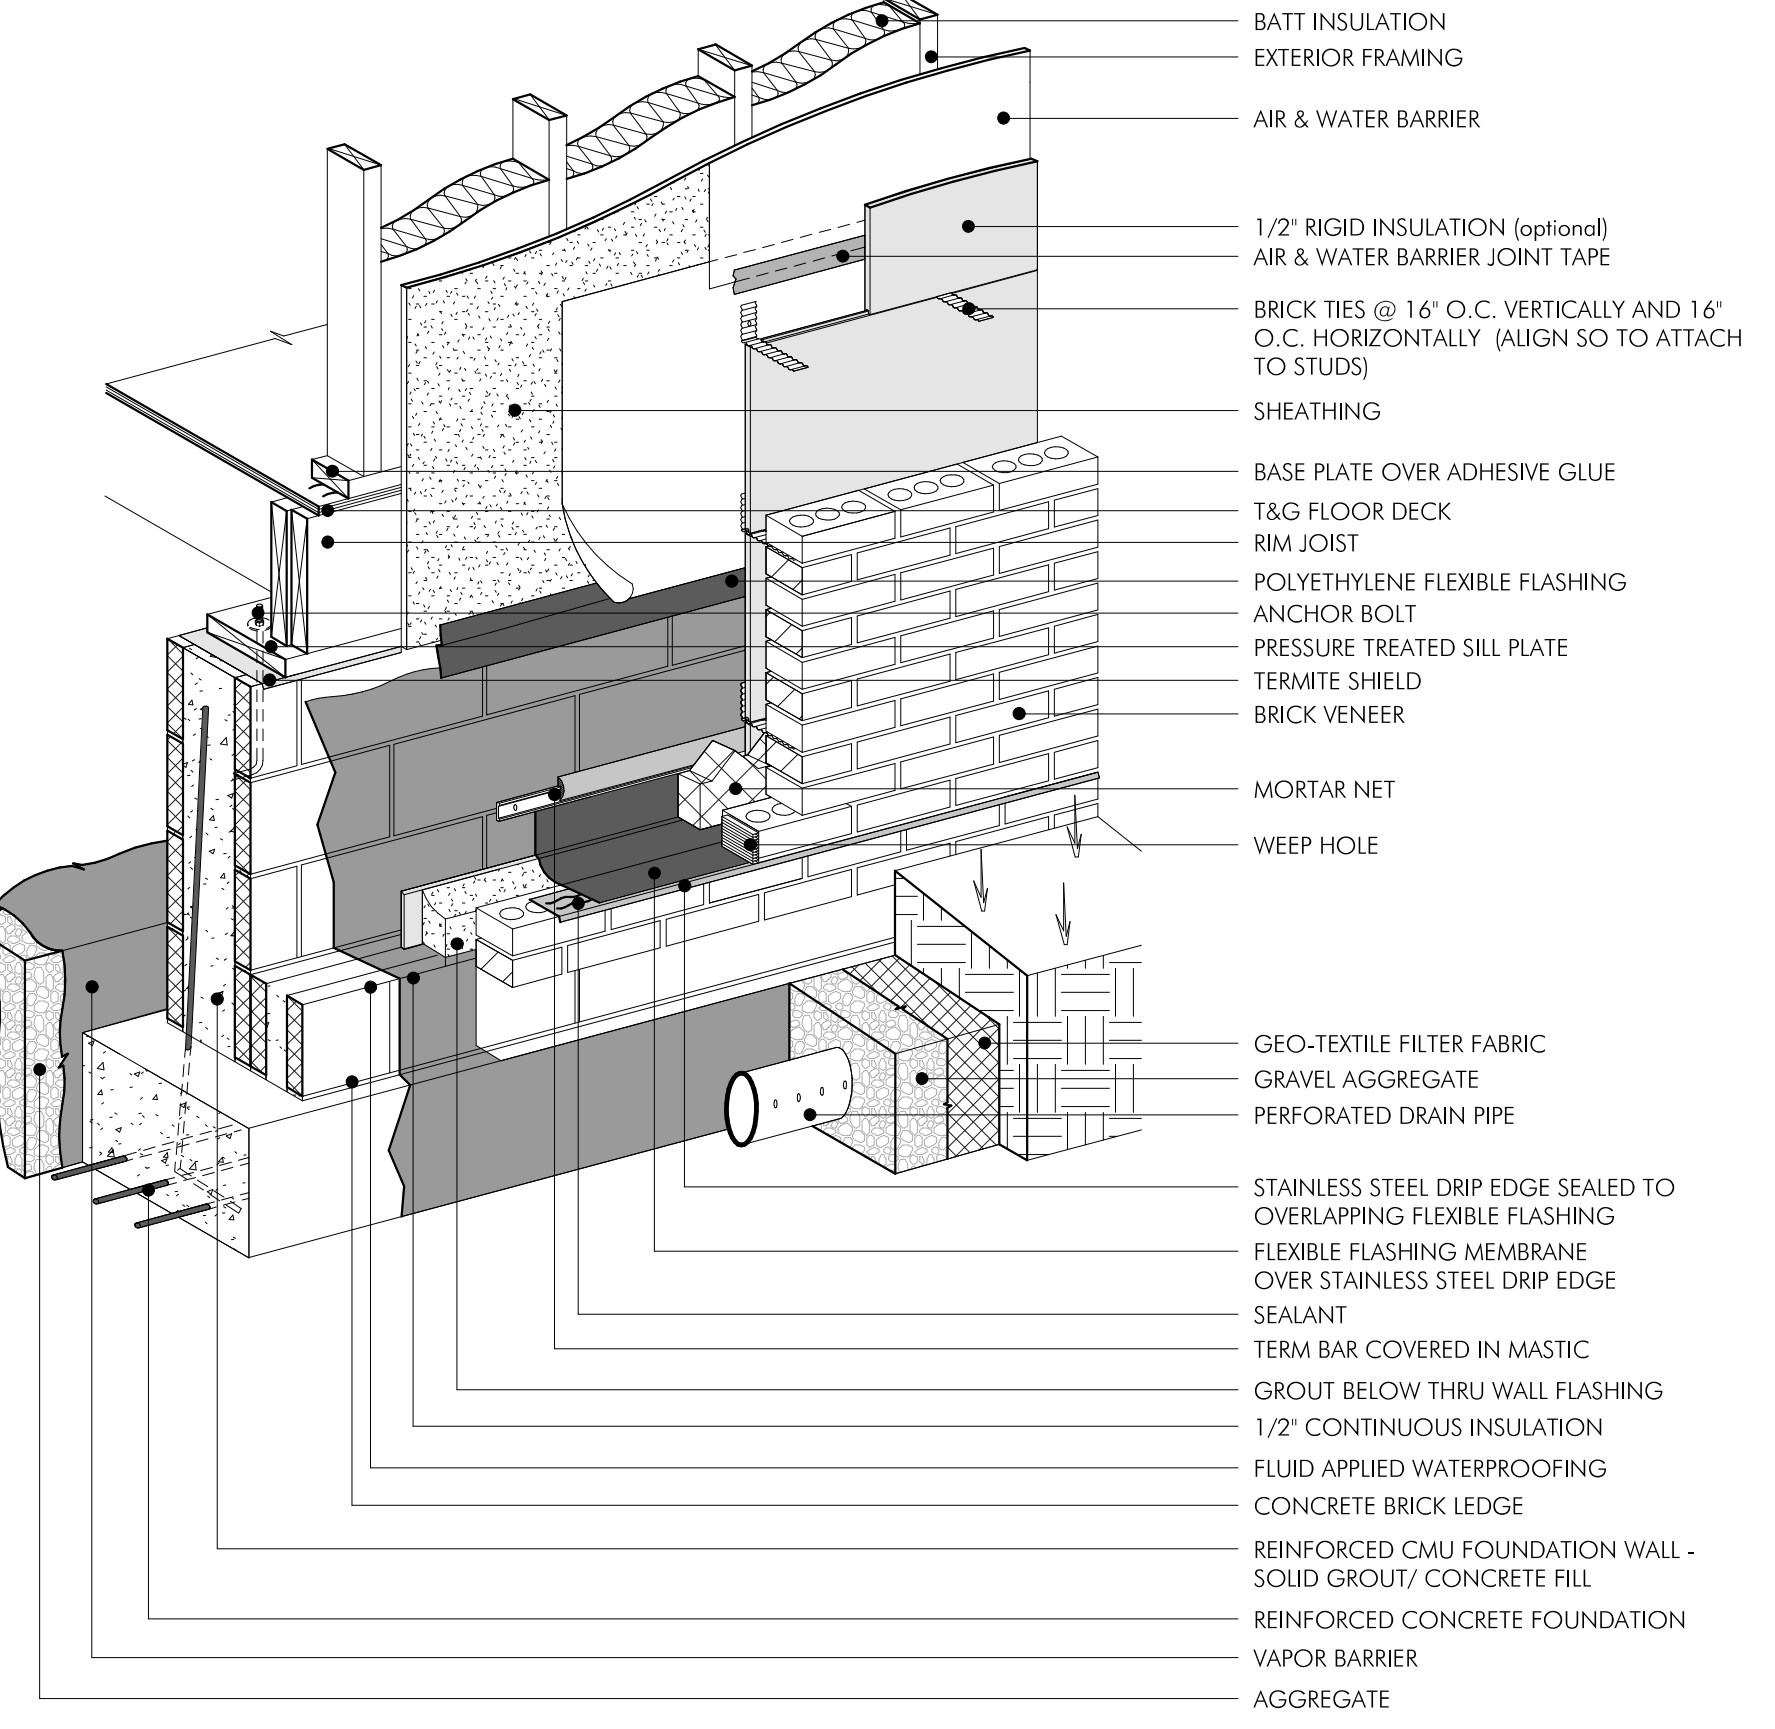

2 BRICK AT FOUNDATION
3/4" = 1'-0"

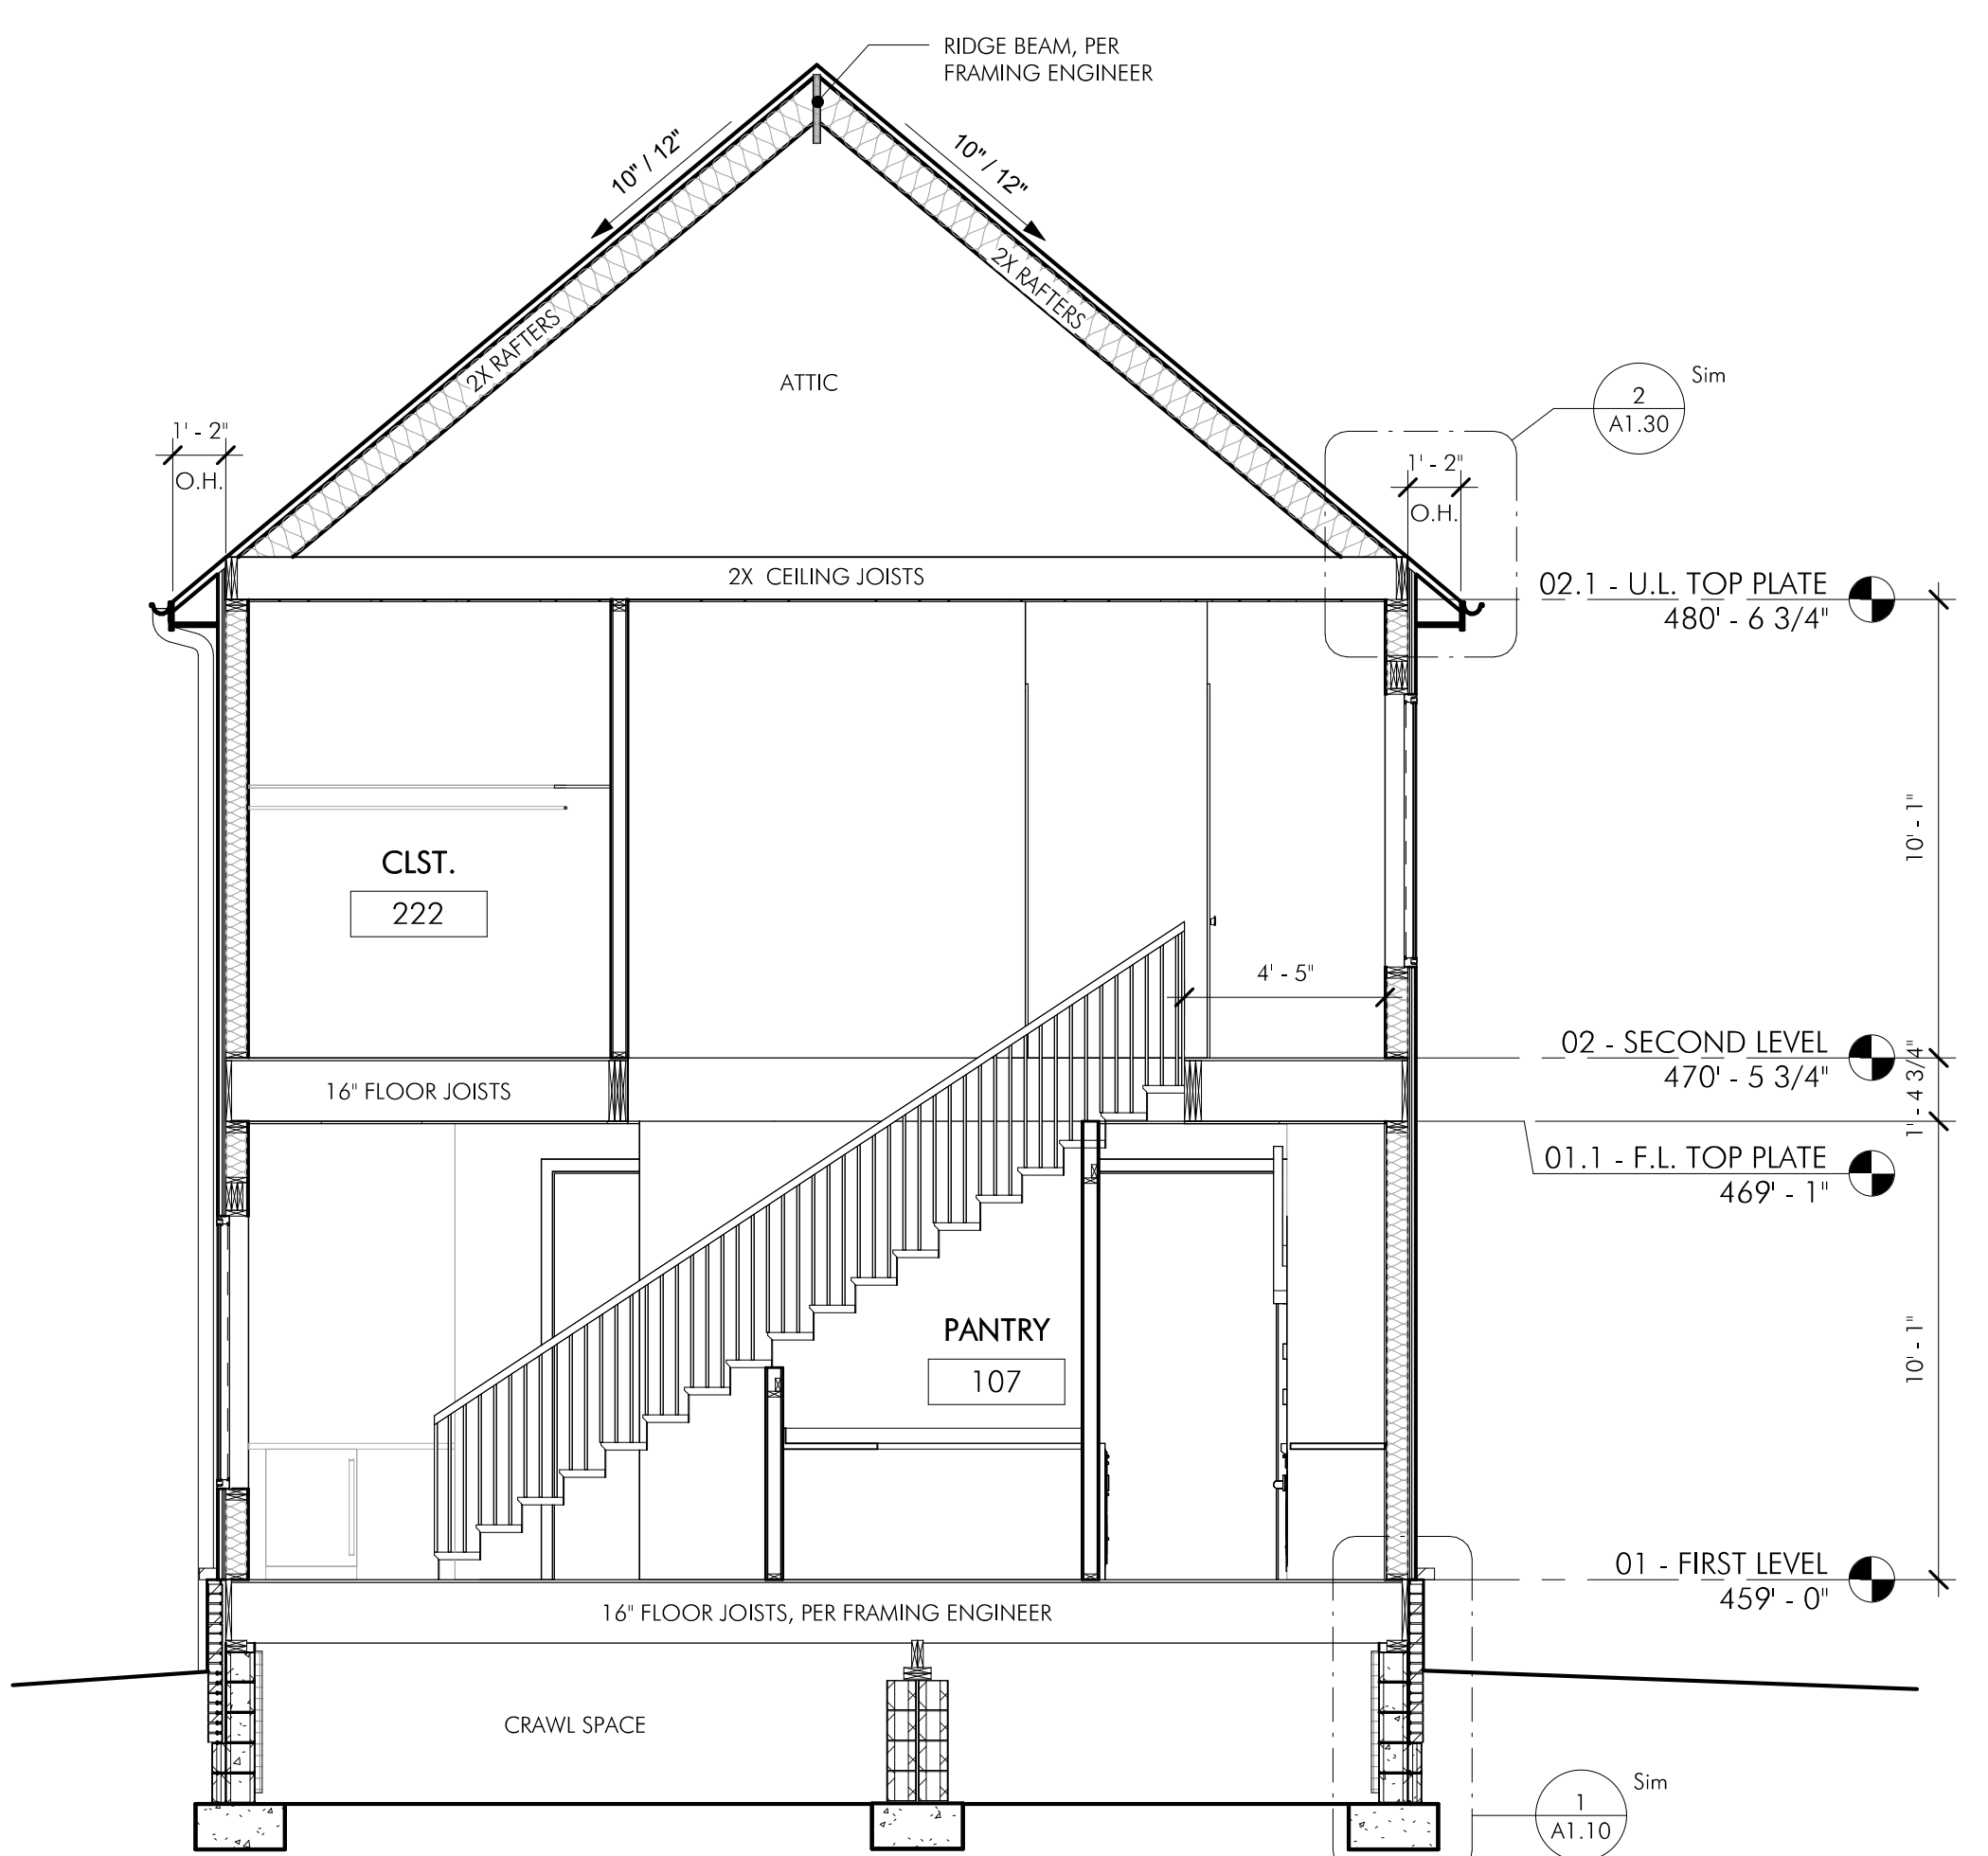

6 Section 2
1/4" = 1'-0"

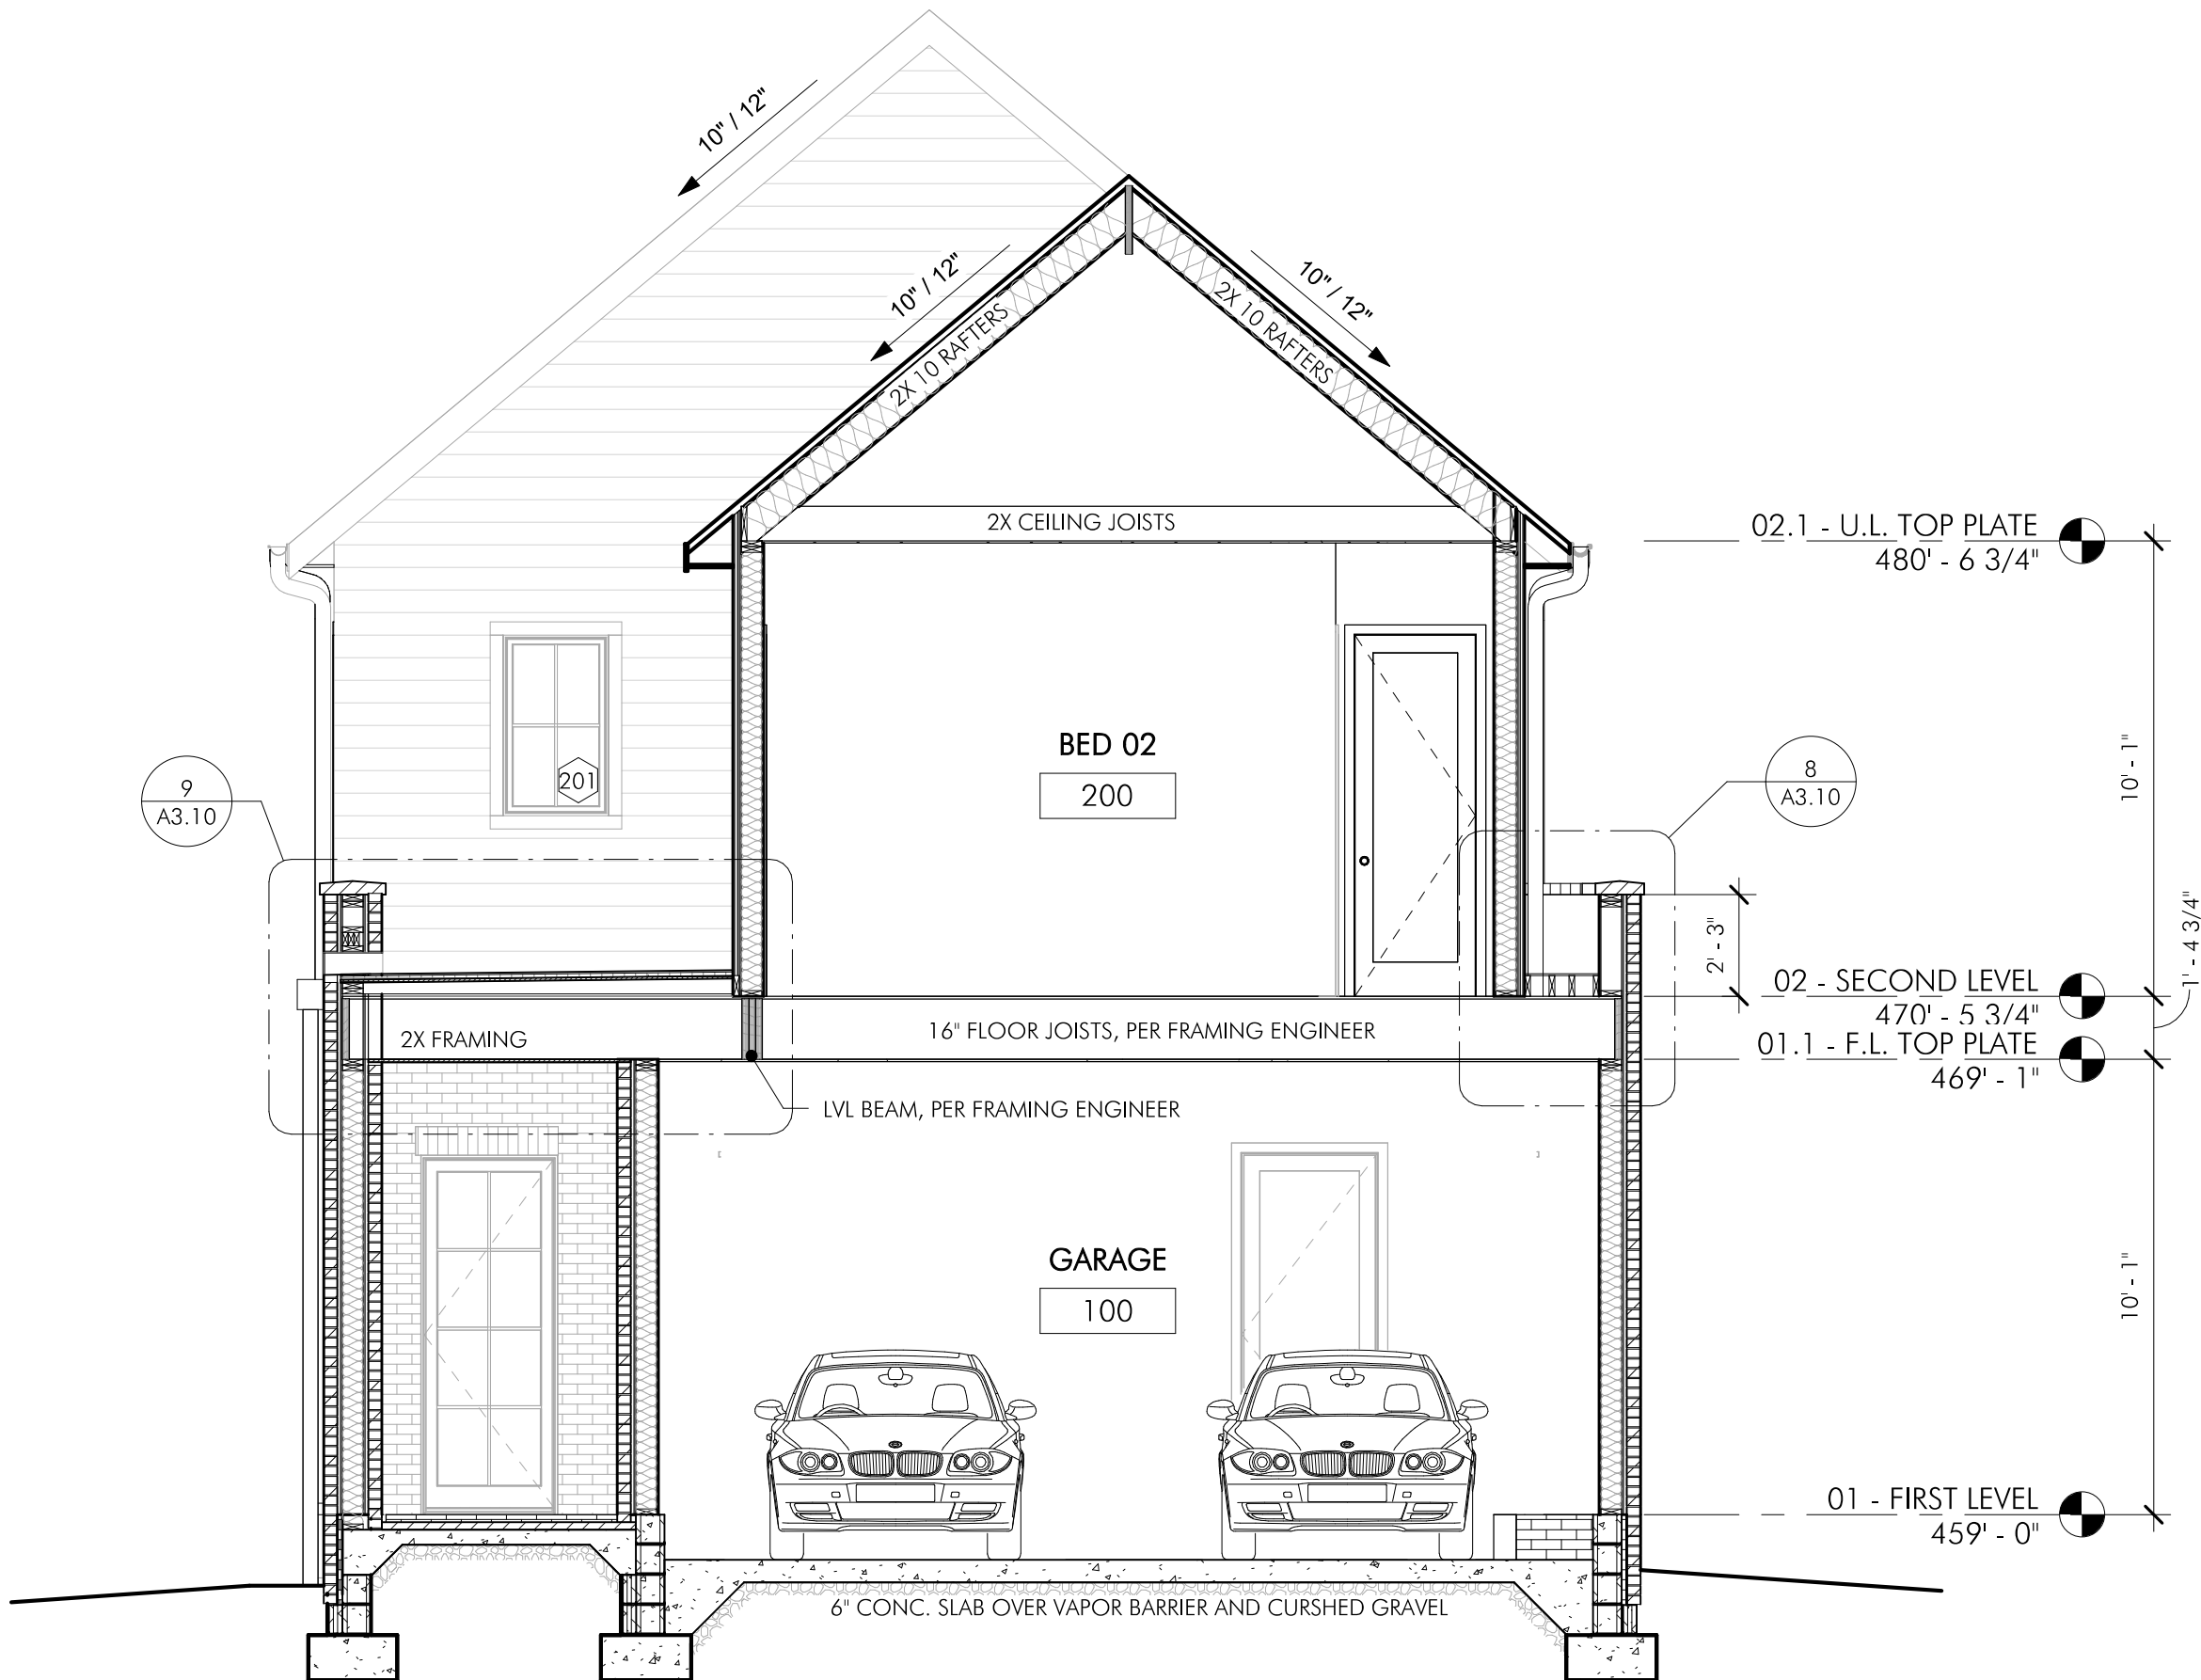

1 Section 1
1/4" = 1'-0"


New Residence for:
MCH Construction of TN

515A Continental Drive
Nashville, TN 37209


PROJECT No. 23205A
DATE: 2023.12.19
REV DATE:

SHEET NAME
SECTION/
DETAILS


SHEET NUMBER
A3.10

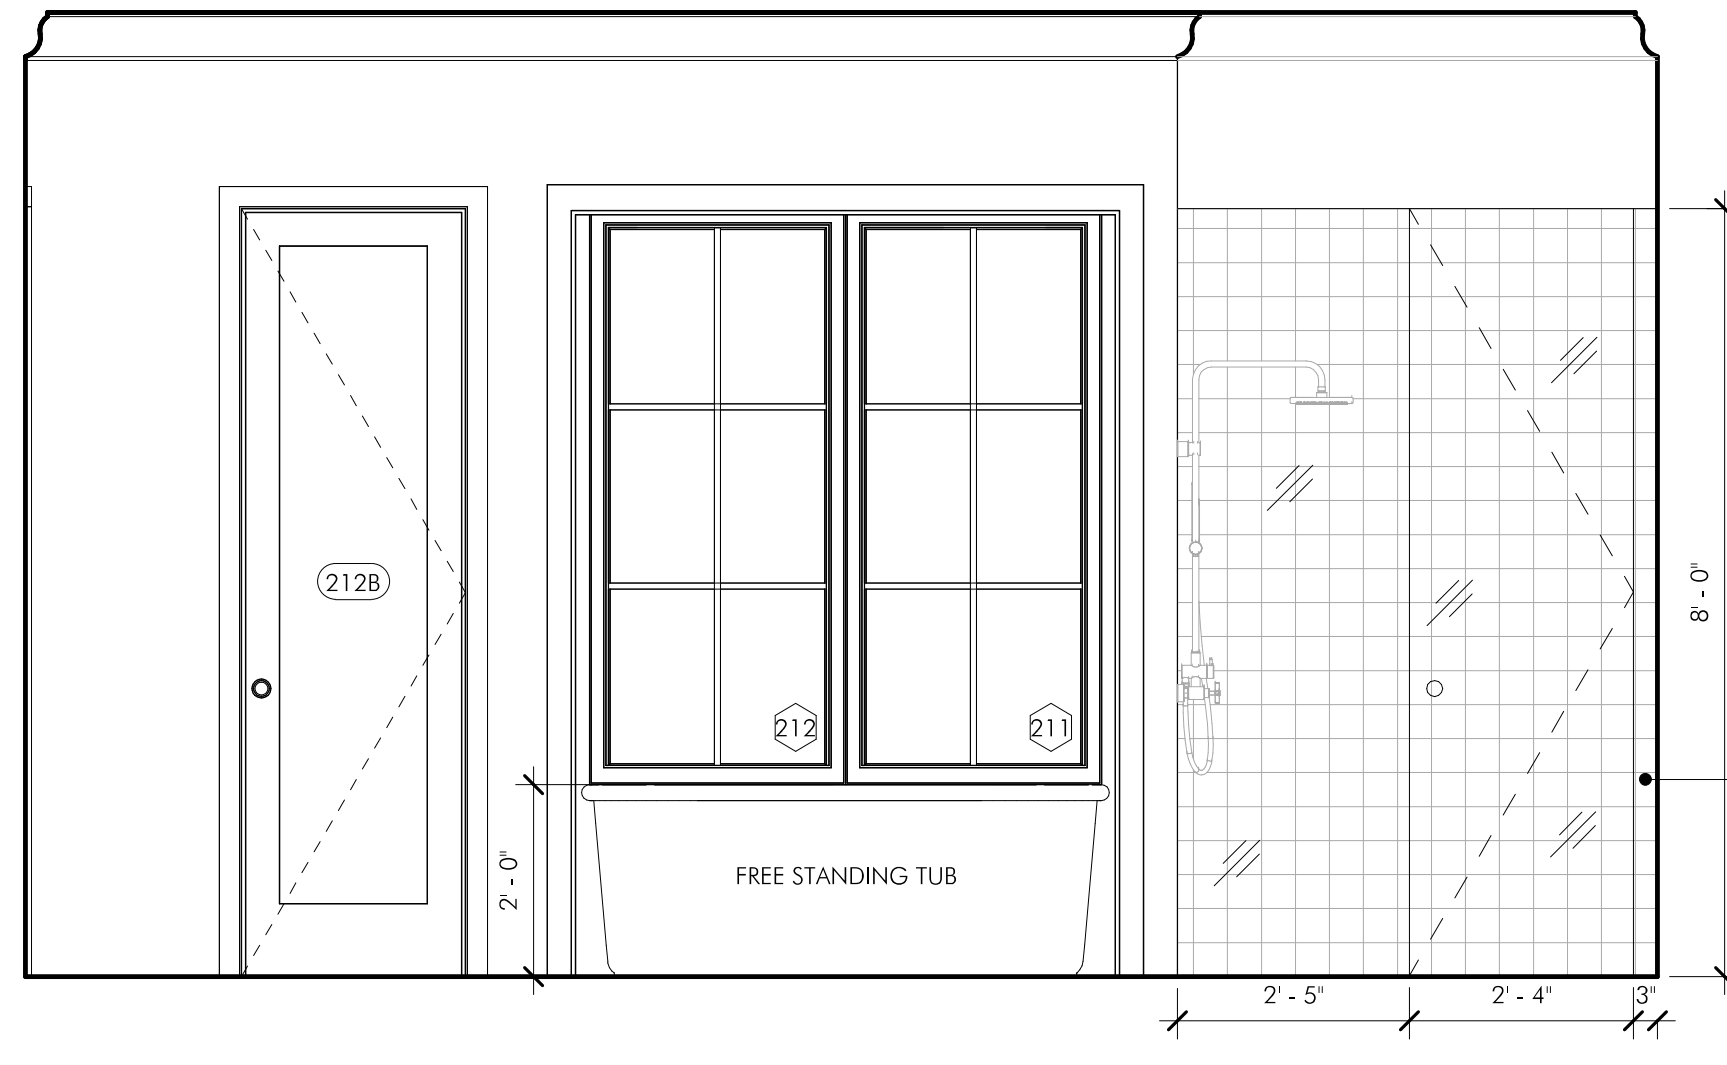


1 PRIMARY BATH - INTERIOR ELEVATION 01
1/2" = 1'-0"

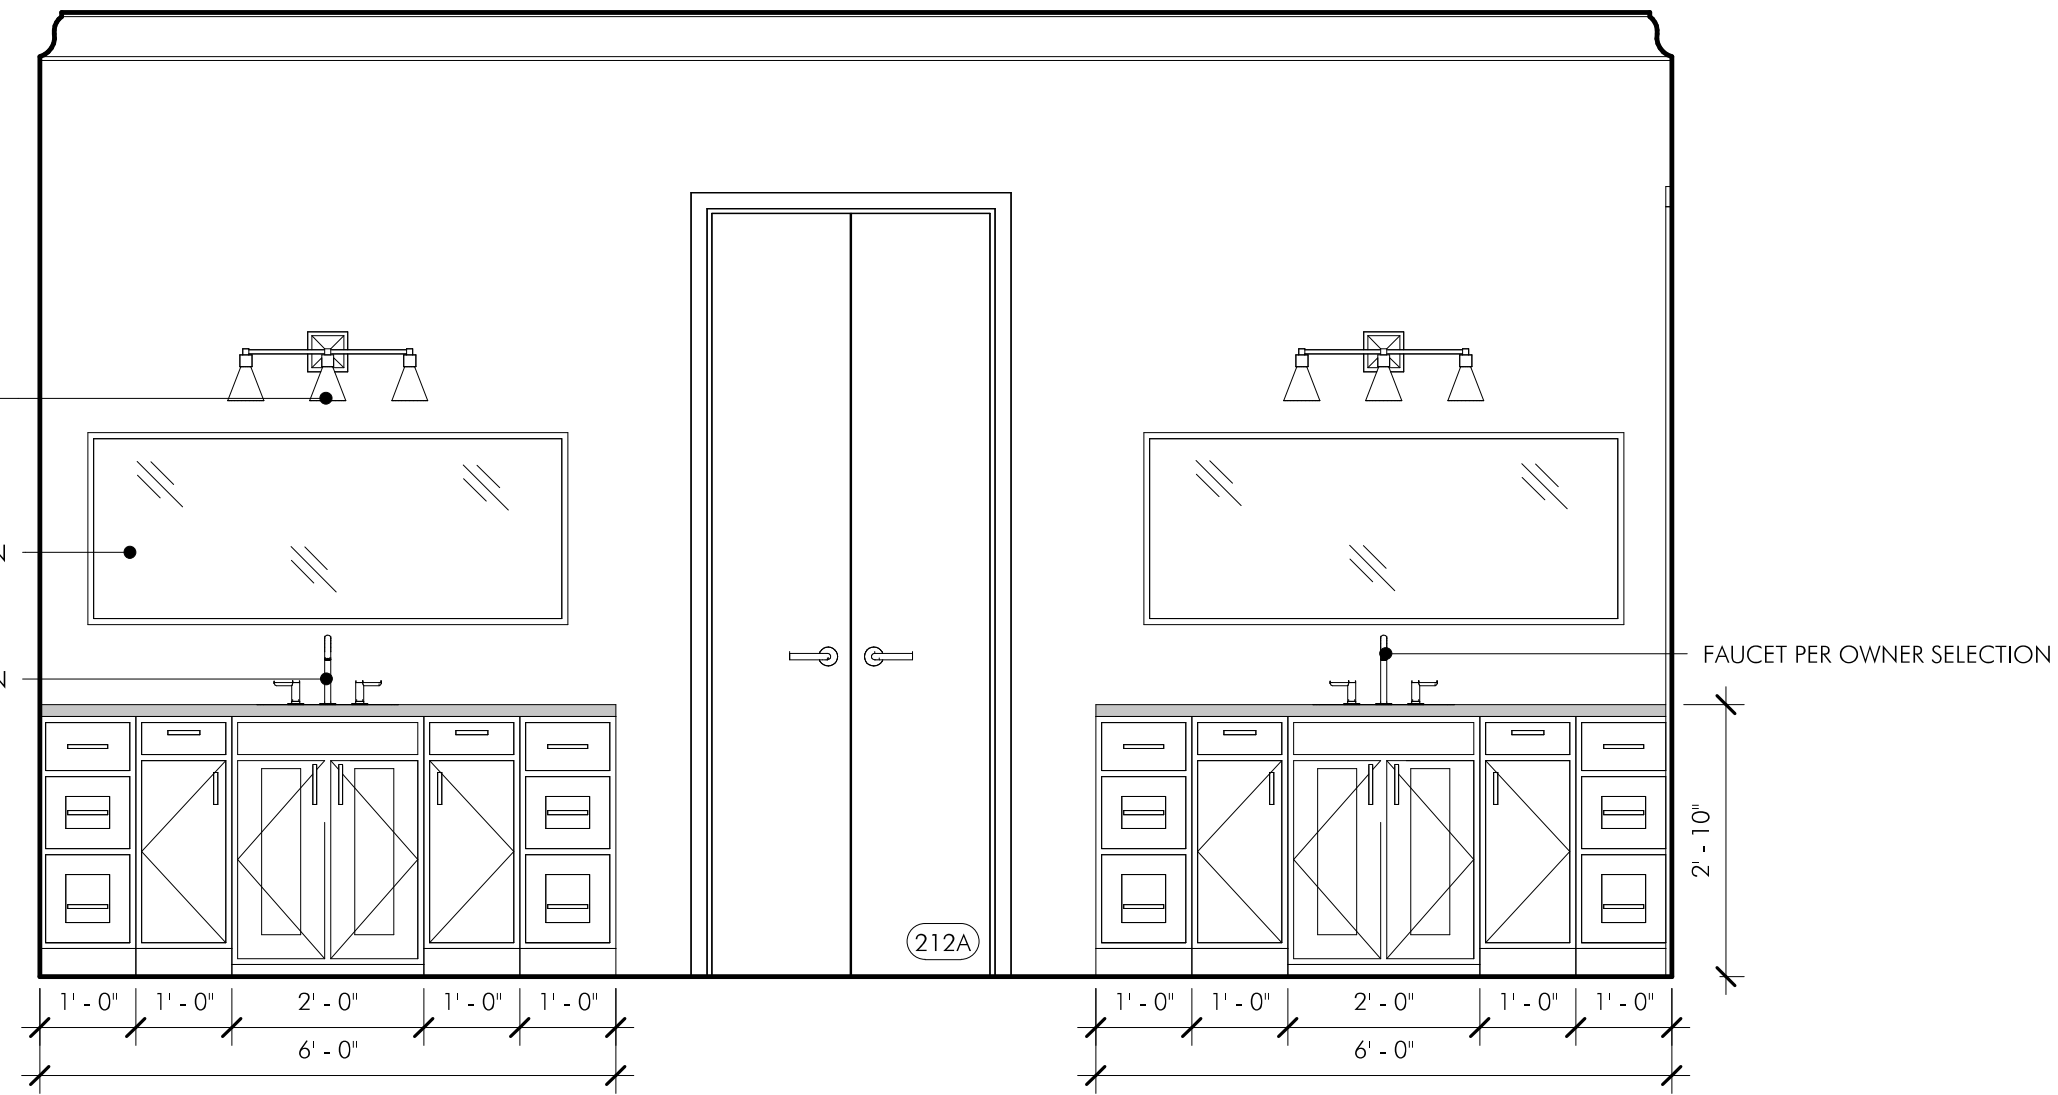


2 PRIMARY BATH - INTERIOR ELEVATION 02
1/2" = 1'-0"

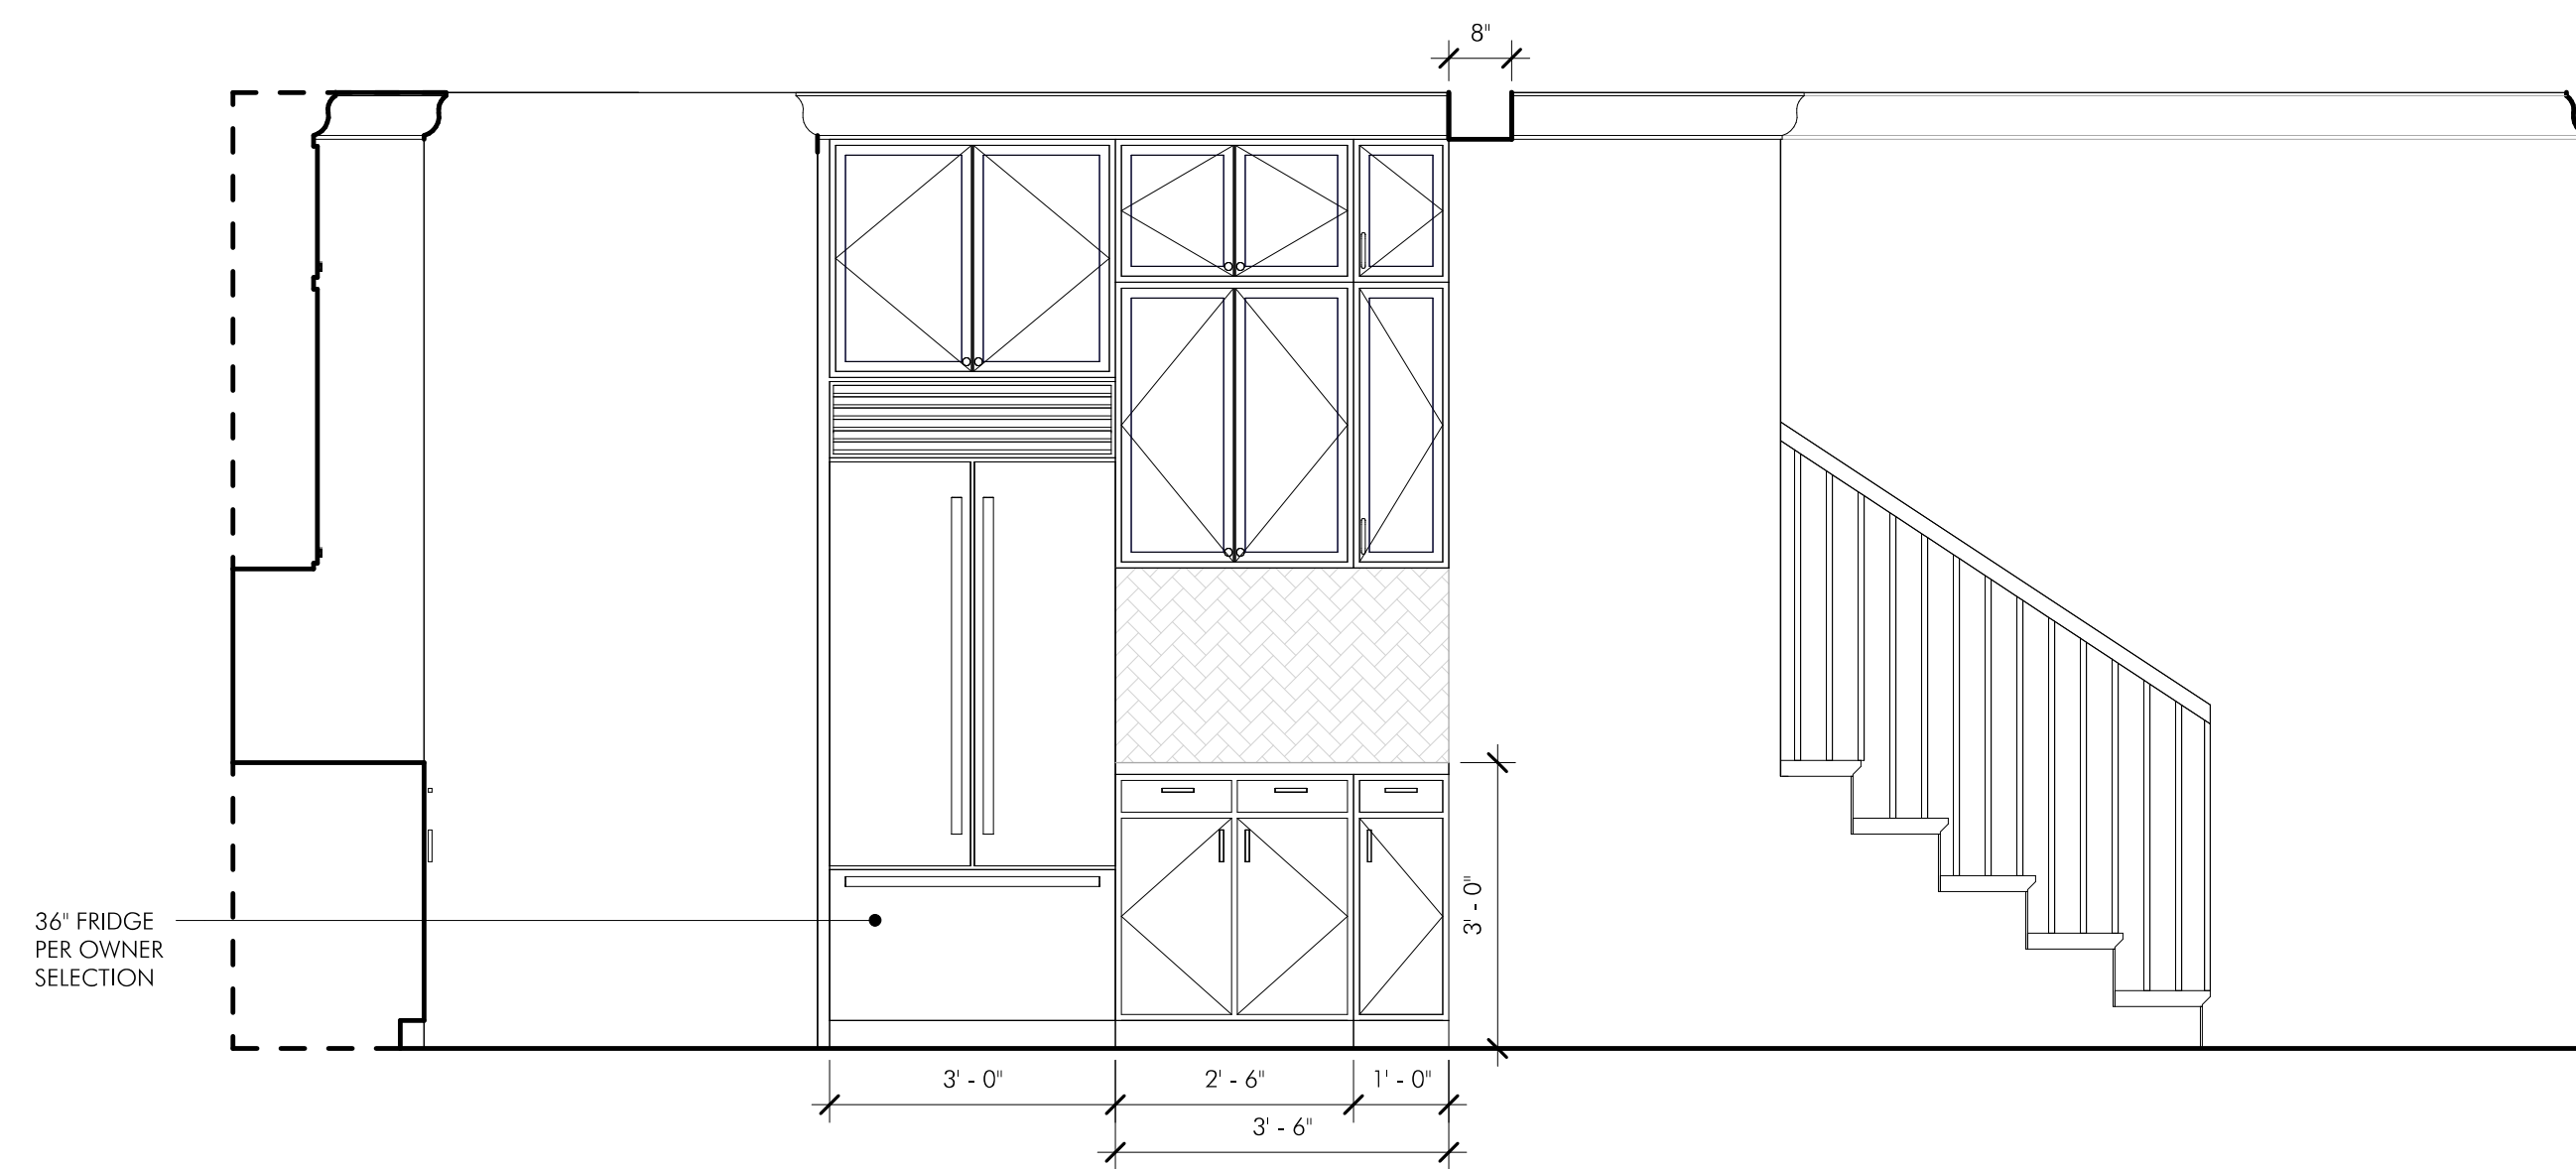


3 KITCHEN - INTERIOR ELEVATION 01
1/2" = 1'-0"

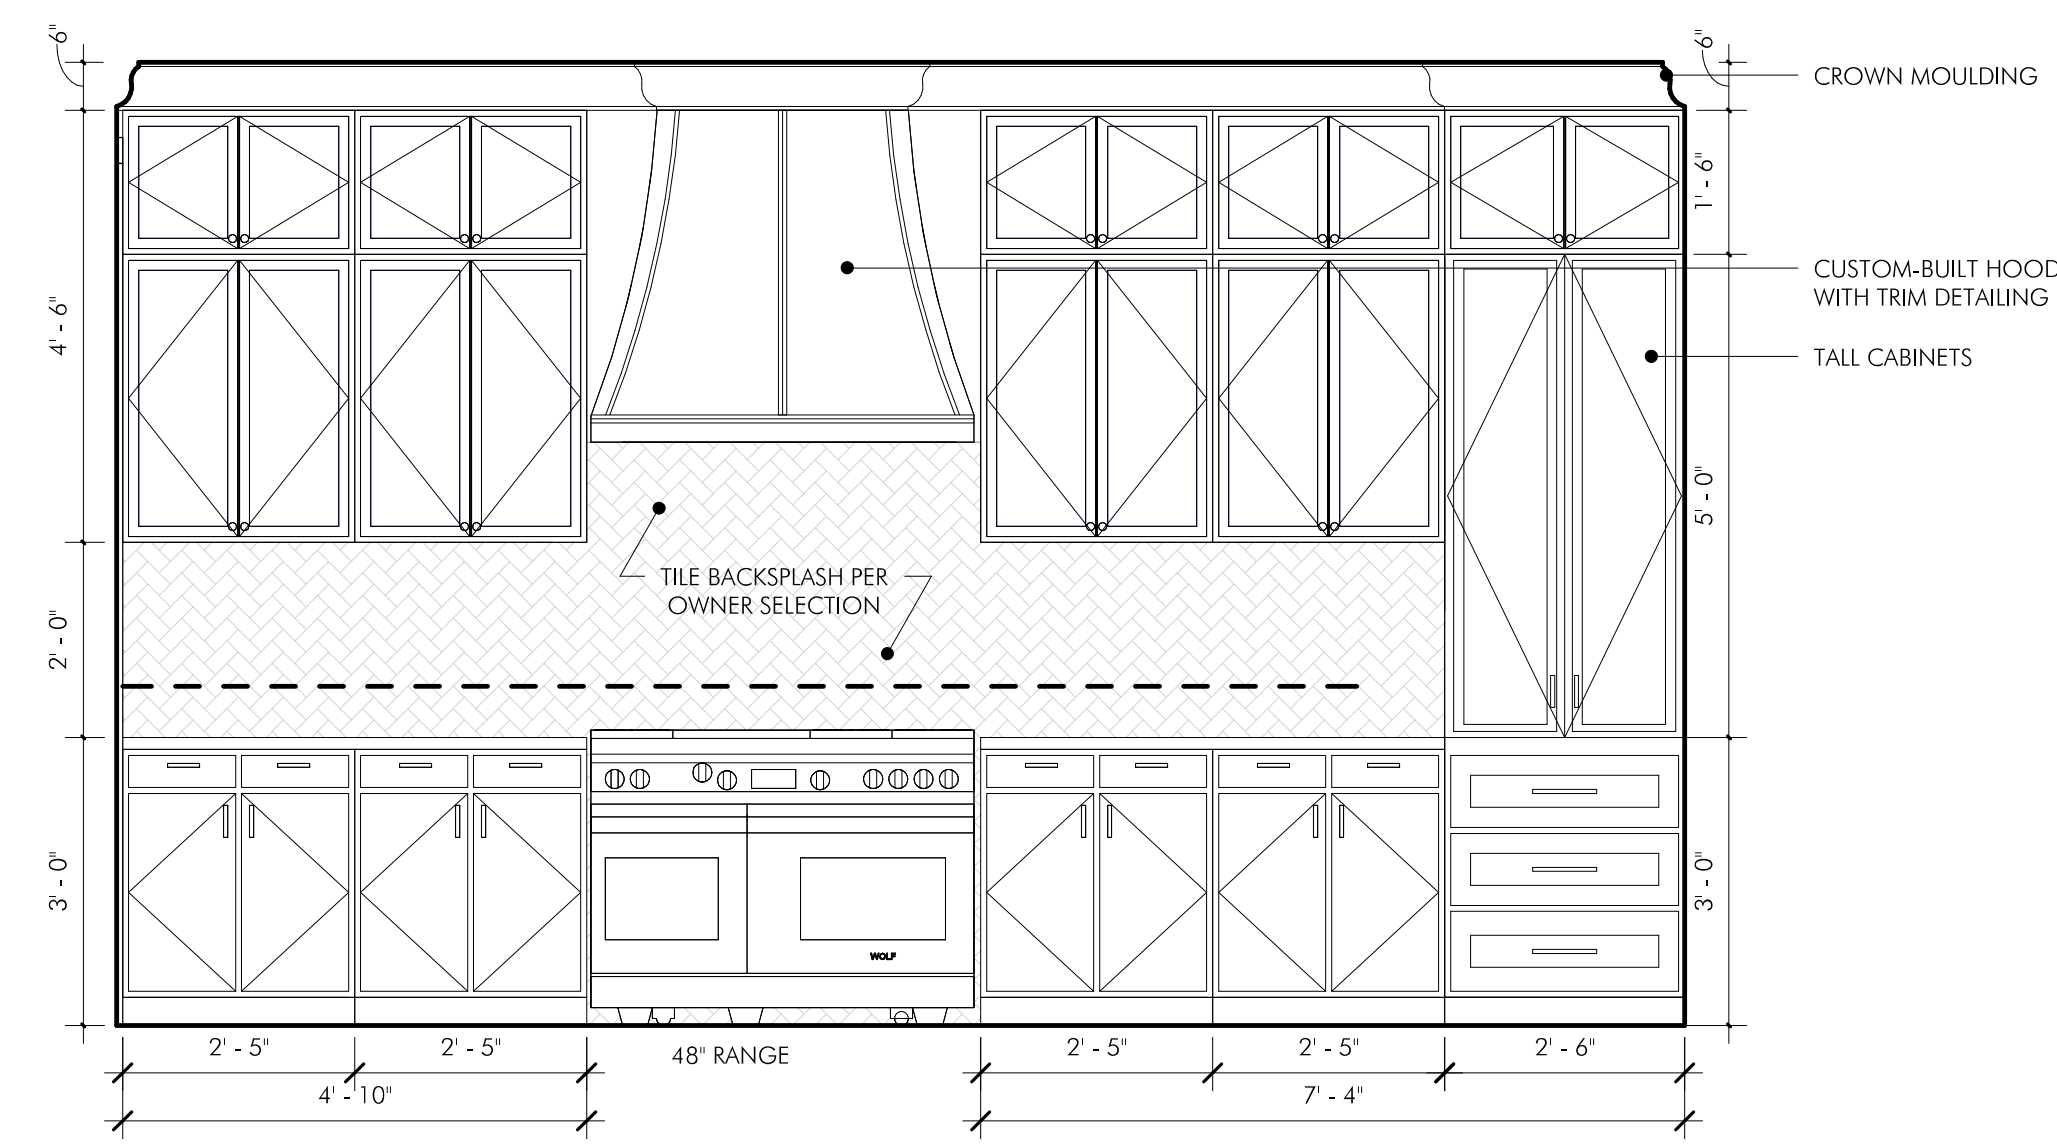

4 KITCHEN - INTERIOR ELEVATION 02
1/2" = 1'-0"

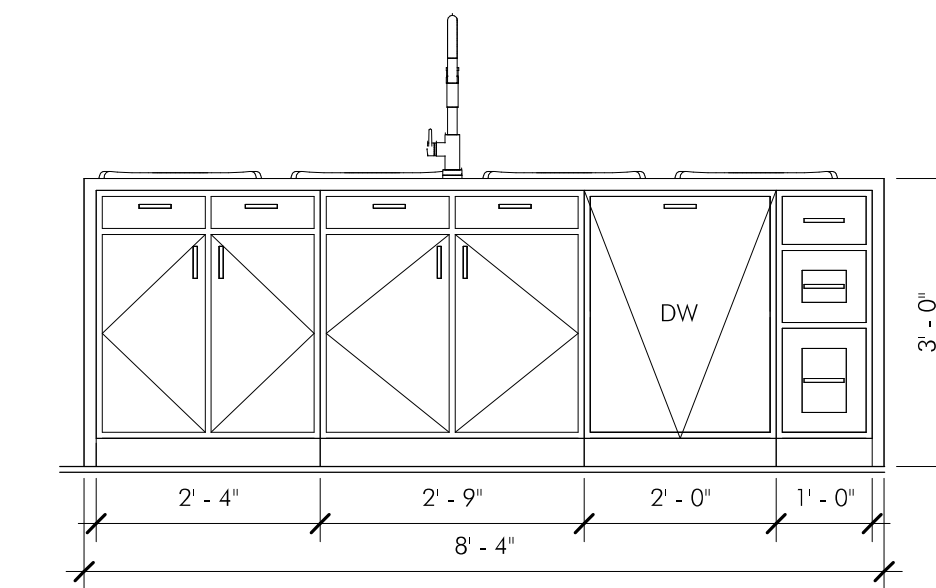

5 KITCHEN ISLAND - INTERIOR ELEVATION 01
1/2" = 1'-0"

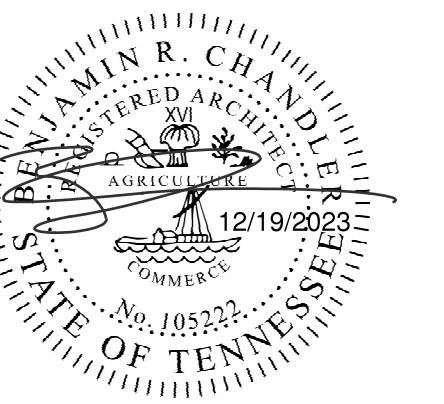

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New Residence for:
MCH Construction of TN

515A Continental Drive
Nashville, TN 37209

PROJECT No. 23205A
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REV DATE:

SHEET NAME
INTERIOR ELEVATIONS

SHEET NUMBER
A7.10